AUCTION SALE

COMMERCIAL/MIXED USE PROPERTY 0.19 +/- ACRES 1,443 SF One-Story Office Building



Teleconference Auction Sale: Wednesday, May 12 at 11:00 AM

> 910 DeKalb Street Montgomery County Norristown, PA 19401

Broker Participation Invited!



215-634-2500 – auctions@comly.com COMLY.COM



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1825 E. Boston Street Philadelphia, PA 19125-1296 215-634-2500 - auctions@comly.com *comly.com*

Welcome...

Comly Auctioneers thanks you for your interest in our teleconference auction sale of the property located at 910 DeKalb Street in Norristown, PA!15 Georgetown Road in Wrightstown, NJ!

Enclosed is the information we have available on the property. We hope you will find it helpful and encourage you to contact our office if you have any questions or would like to schedule a preview of the property.

Happy Bidding!

Under & Younky

Andrew J. Comly Real Estate Broker #8230738



ABOUT COMLY

Comly Auctioneers & Appraisers strives to continually provide professional auction, appraisal, liquidation and real estate services leading toward solutions that exceed the expectations of our clients.

As one of the oldest family owned and operated auction firms in the United States, Comly Auctioneers & Appraisers offers a full range of auction, appraisal, inventory & real estate services to meet every demand.

The Comly family's seventh generation continues the unsurpassed performance and dedication that first solidified the firm's reputation in 1834.

After everything we have learned during our 187 years of industry leadership, we like to stick with the basics:

Integrity, Service and Commitment. It's that simple.

Over 187 years of industry leadership is ready to work for you. Whether it is a residential, commercial, industrial or multi-parcel sale, our services are ready at a moment's notice.

*Interested in selling your property at auction? Contact Andy Comly at (215) 634-2500




Property Information


Auction Date & Time:	Wednesday, May 12 at 11:00 AM Telephone Bidding Only!	
Property Location:	910 DeKalb Street Montgomery County Norristown, PA 19401	
Parcel:	13-00-09636-00-8	
Block:	203901	
Tax Map ID:	13027 001	
Taxes:	\$5,227.00	
Zoning:	C-Commercial	
Exterior Size:	8,400 SF	
Interior Size:	1,443 SF	
Year Built:	1899	
Parking:	15-18 Car Parking Lot in Rear	
Heating/Cooling:	Forced Air & Central Air (2020)	
Electrical:	New (2020)	
Roof:	Restored (2020)	
Permitted Uses:	Retail stores for food, drugs, vape, supplies, hardware, furnishings, bakery & variety of merchandise. Service shops including barber shop, hair styling, nail salon, automotive parts, professional office, doctor, lawyer, insurance, counseling, restaurant, taverns & saloons.	

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Google Maps 910 DeKalb St

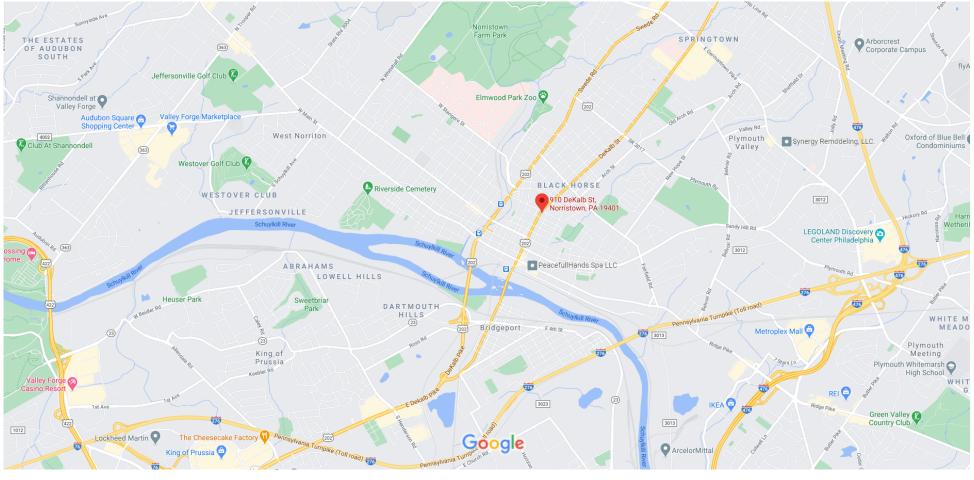

Map data ©2021 Google 2000 ft ■_____



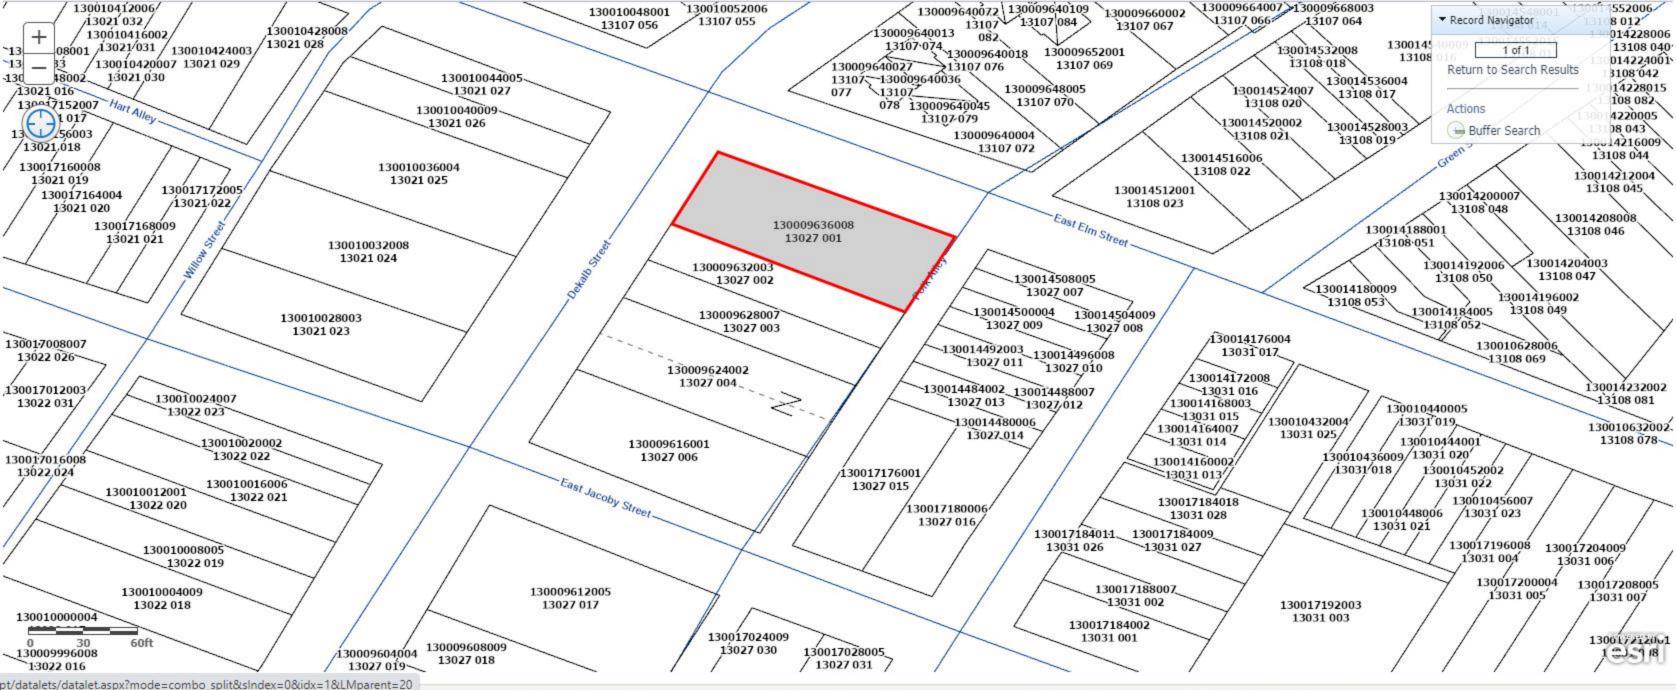
































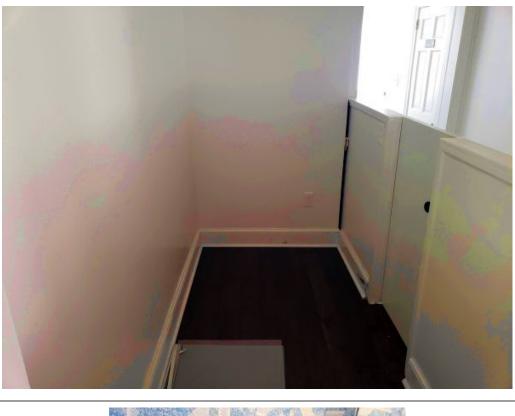


























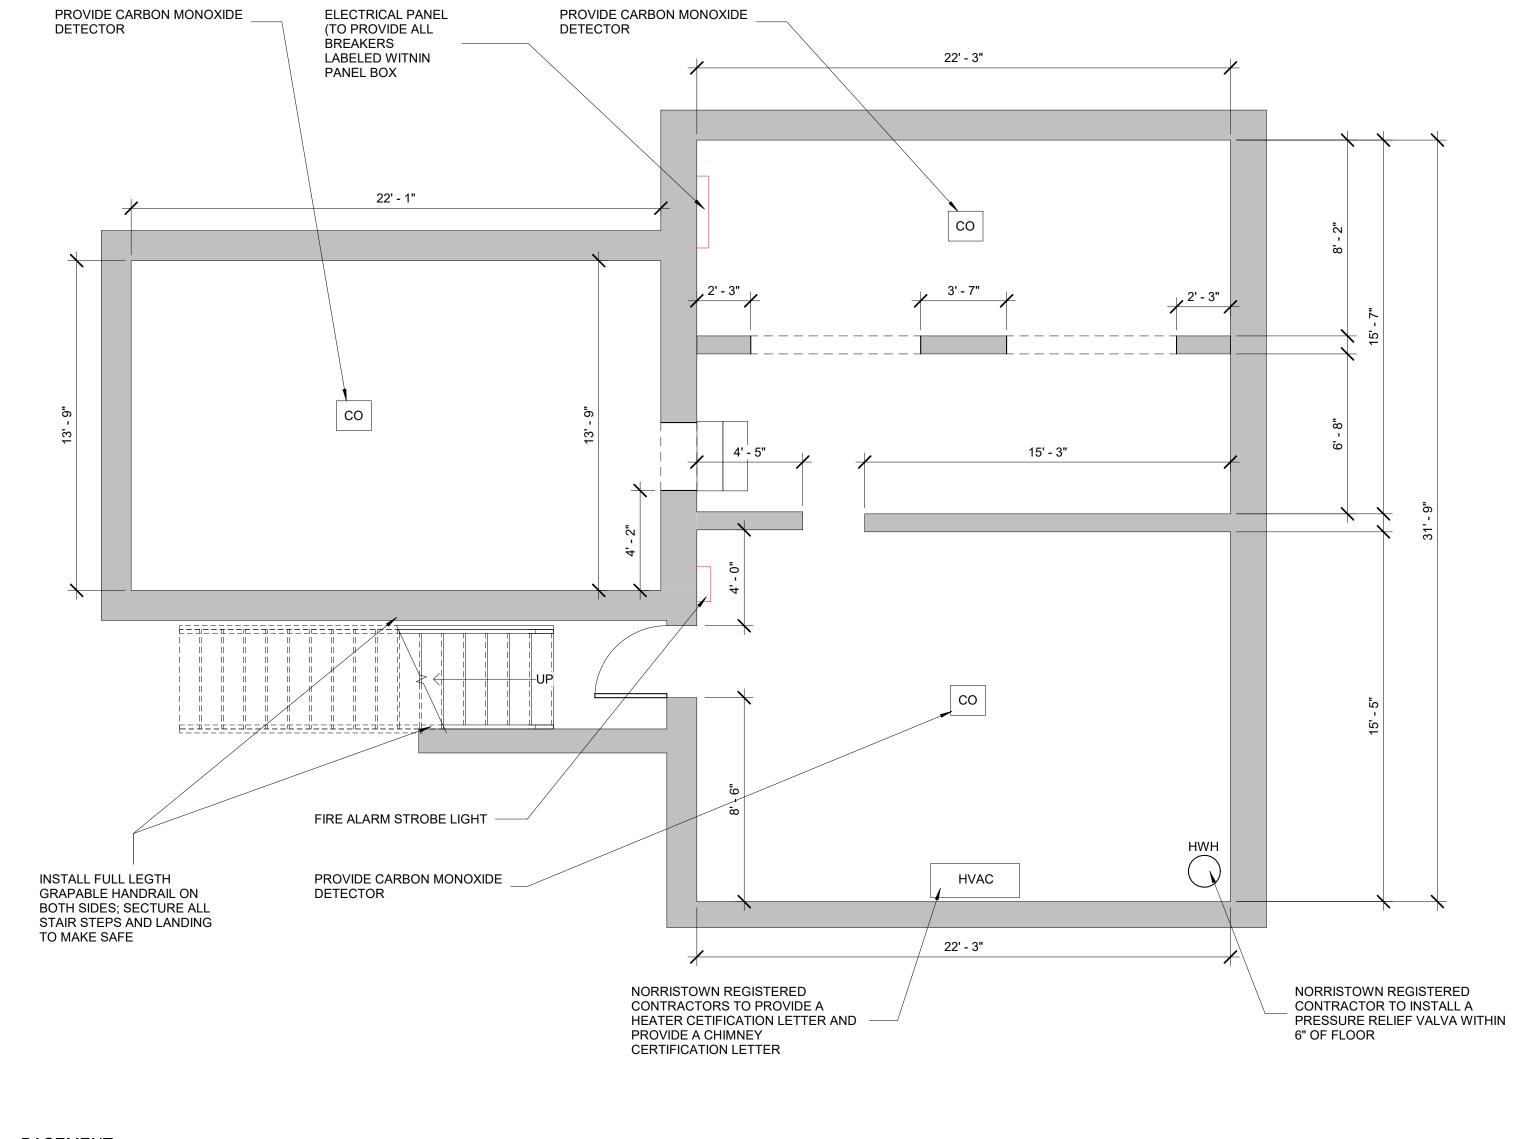


1 BASEMENT 1/4" = 1'-0"

DIRECTORY

CLIENT LAMAR

ARCHITECT SKY DESIGN STUDIO 1823 SPRING GARDEN ST PHILADELPHIA, PA 19130 ATTN: T: 610-896-3649 F: 215-827-5370 EMAIL: SKY@SKY-DS.COM

MEP ENGINEER

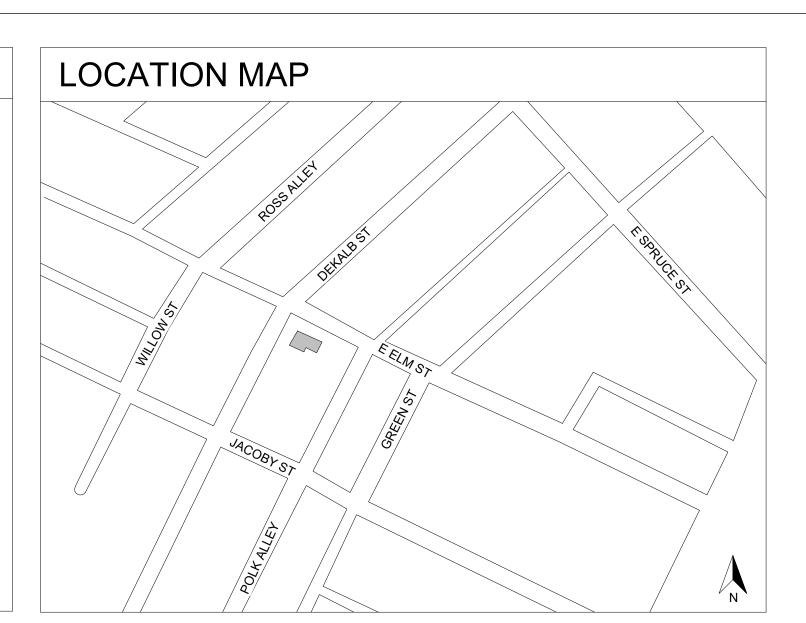

DRAWING INDEX

SHEET NUMBER	SHEET NAME
CS1	COVER SHEET, BASEMENT FLOOR PLAN, BUILDING INFO
A01	EXISTING FLOOR PAN, POPOSE FLOOR PLAN
A02	ADA GUIDELINE, BATHROOM ELEVATIONS

PROJECT INFO

BUILDING ADDRESS: 910 DEKALB ST, NORRISTOWN, PA, 19401 SCOPE OF WORK: ADD ADA BATHROOM

BUILDING DATA

OCCUPANCY GROUP

TOTAL FLOOR AREA (EXCLUDING BASEMENT) - 1 ST FLOOR CODE REFERENCE

NC (NEIGHBORHOOD COMMERCIA) EXISTING

N-C

1227 SF PENNSYLVANIA UNIFORM CONSTRUCTION CODE PA UCC

SKY DESIGN STUDIO

T 610 896 3649 F 215 827 5370 1823 SPRING GARDEN ST PHILADELPHIA, PA 19130

SKY@SKY-DS.COM

PROJECT ADDRESS

910 DEKALB ST, NORRISTOWN, PA, 19401

OWNER

QORE DEVELOPEMENT INC

CONSULTANT

XXXXXXXXXXXXXXXXXXXXX XXXXXXXXXXXXX, XX XXXXX

SUBMISSION

BUILDING PERMIT REVIEW 2020.07.28

GENERAL NOTE

GENERAL CONTRACTOR IS RESPONSIBLE FOR CHECKING & VERIFYING ALL DIMENSIONS. PRIOR TO & DURING CONSTRUCTION. ANY INCONSISTENCIES SHALL BE BROUGHT TO THE IMMEDIATE ATTENTION OF THE ARCHITECT FOR RESOLUTION OR VERIFICATION. CONTRACTOR IS RESPONSIBLE FOR NOTIFYING THE ARCHITECT OF ANY INCONSISTENCIES BETWEEN THESE PLANS AND ANY GOVERNING BUILDING CODES OR ORDINANCES. CONTRACTOR SHALL CHECK WITH THE ARCHITECT (10) DAY PRIOR TO START OF CONSTRUCTION FOR ADDENDUMS OR BULLETINS.

SEAL





DRAWING NUMBER

INFO

















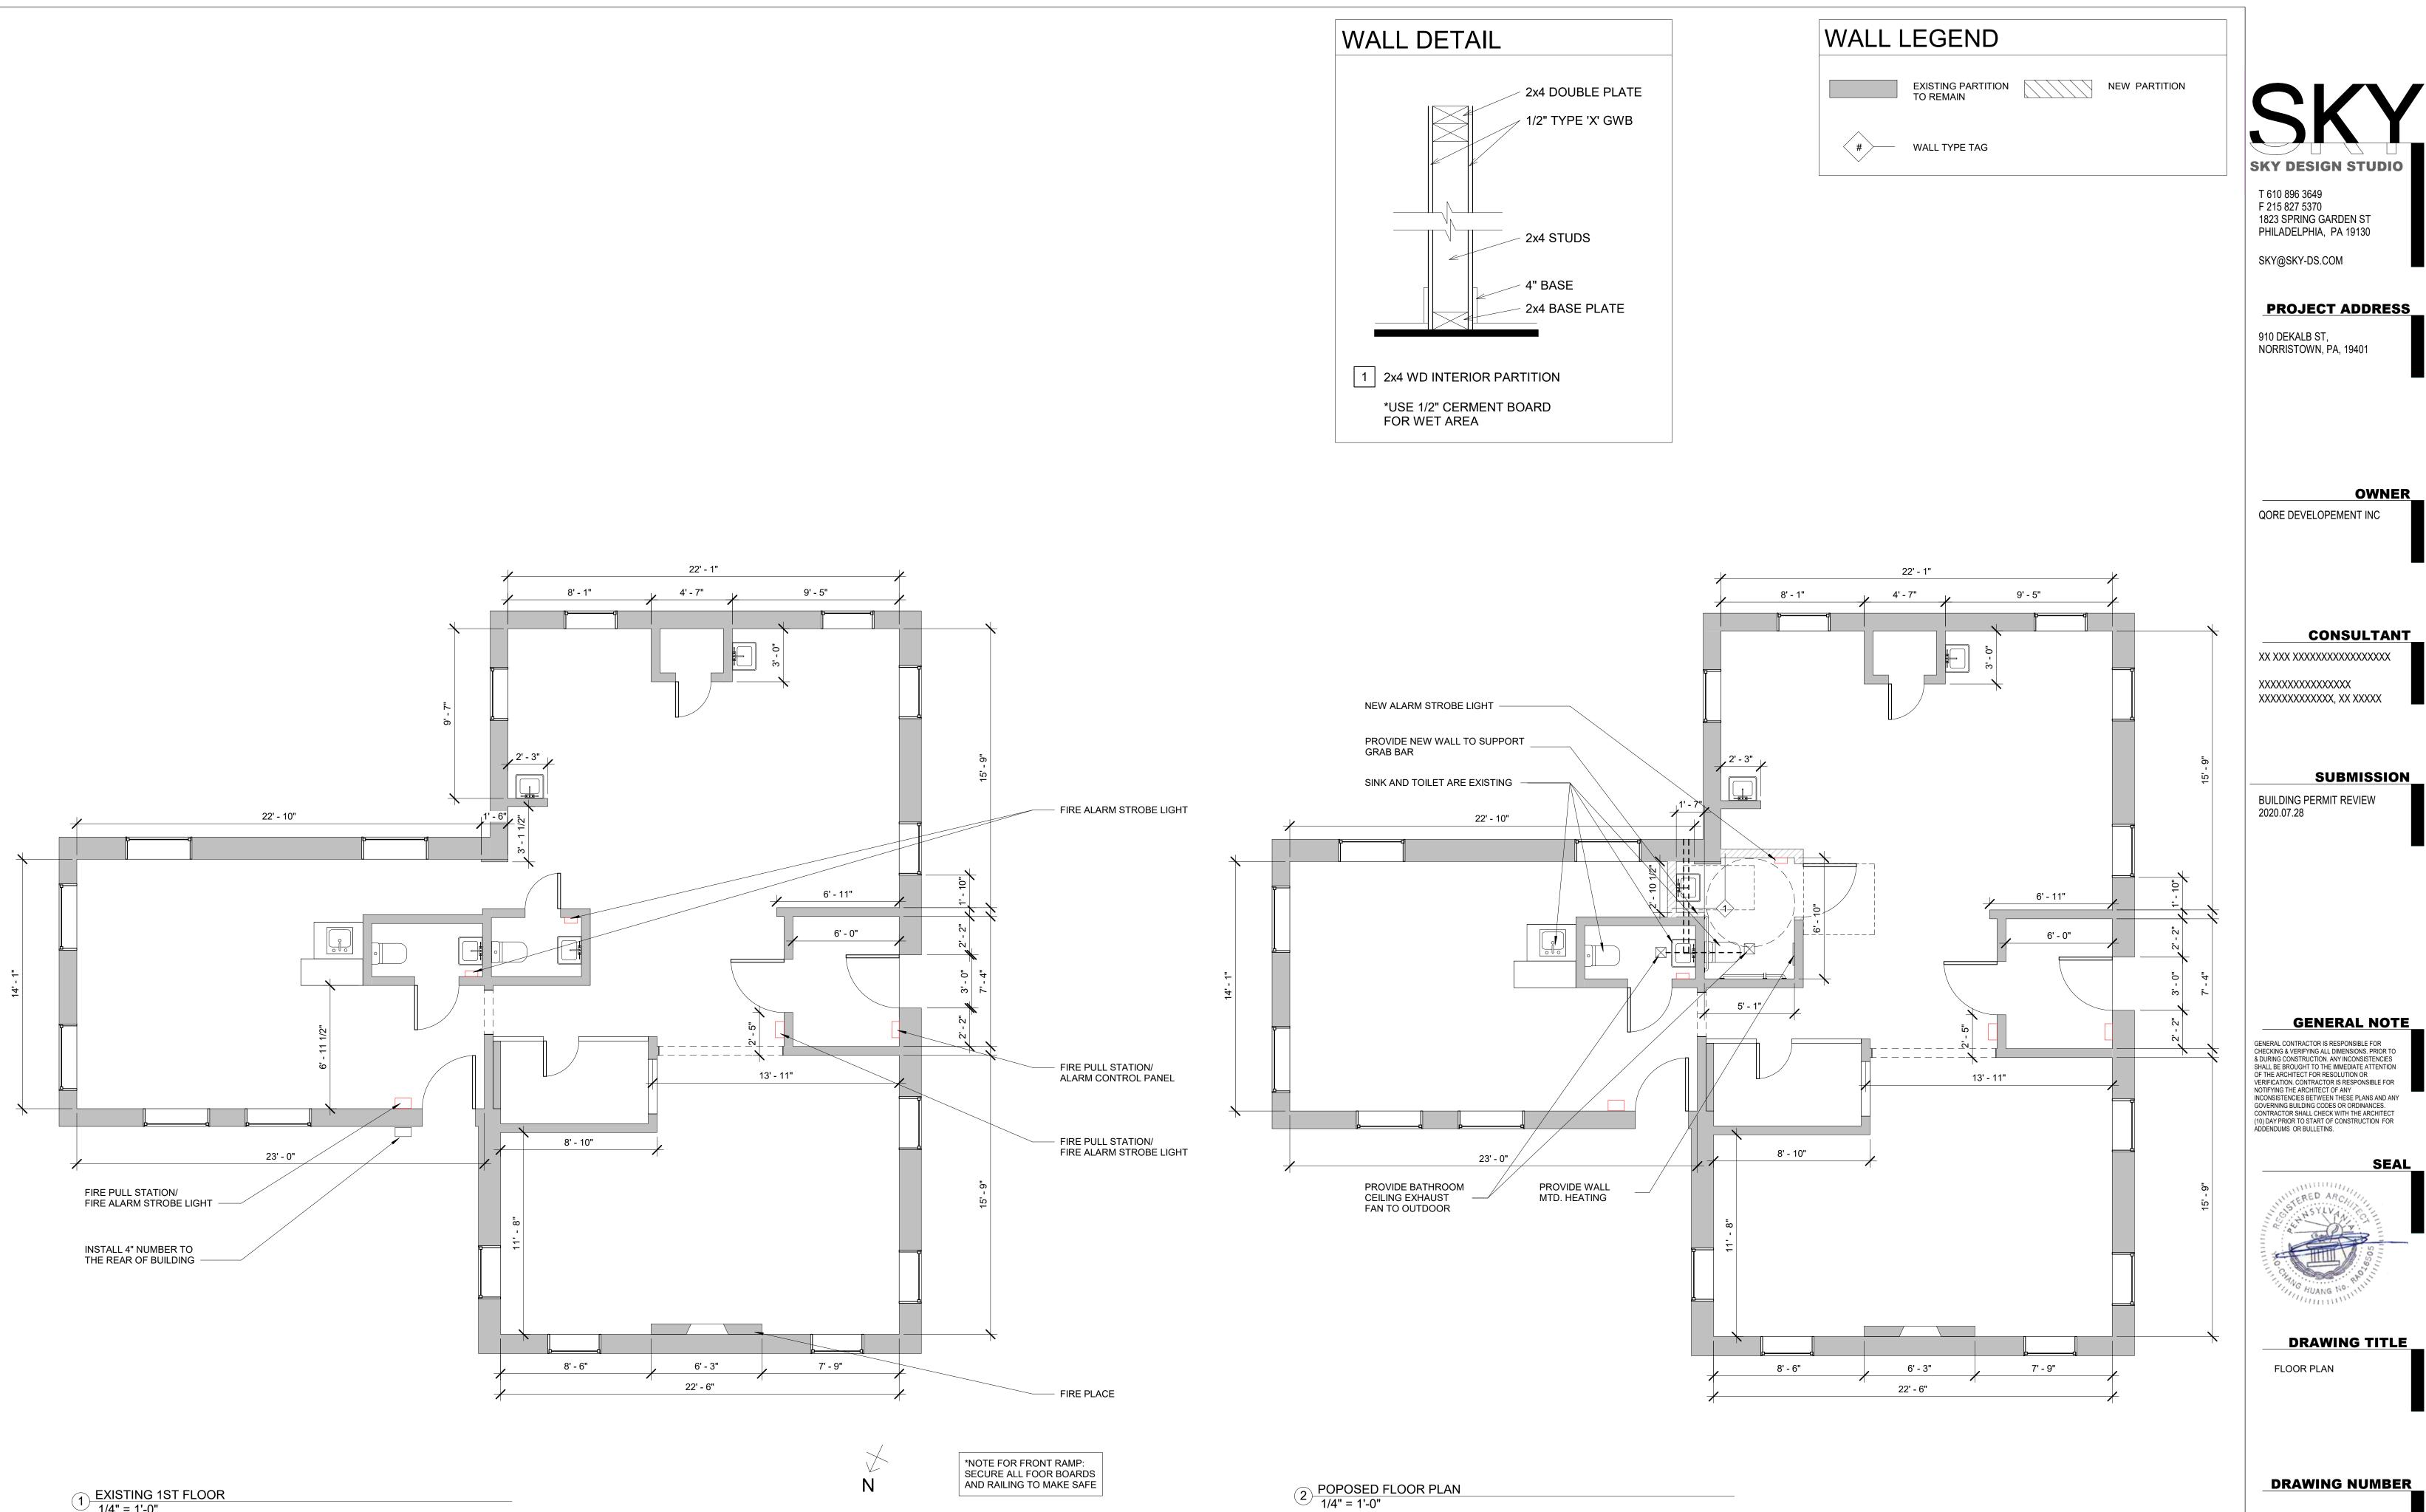



1) EXISTING 1ST FLOOR 1/4" = 1'-0"

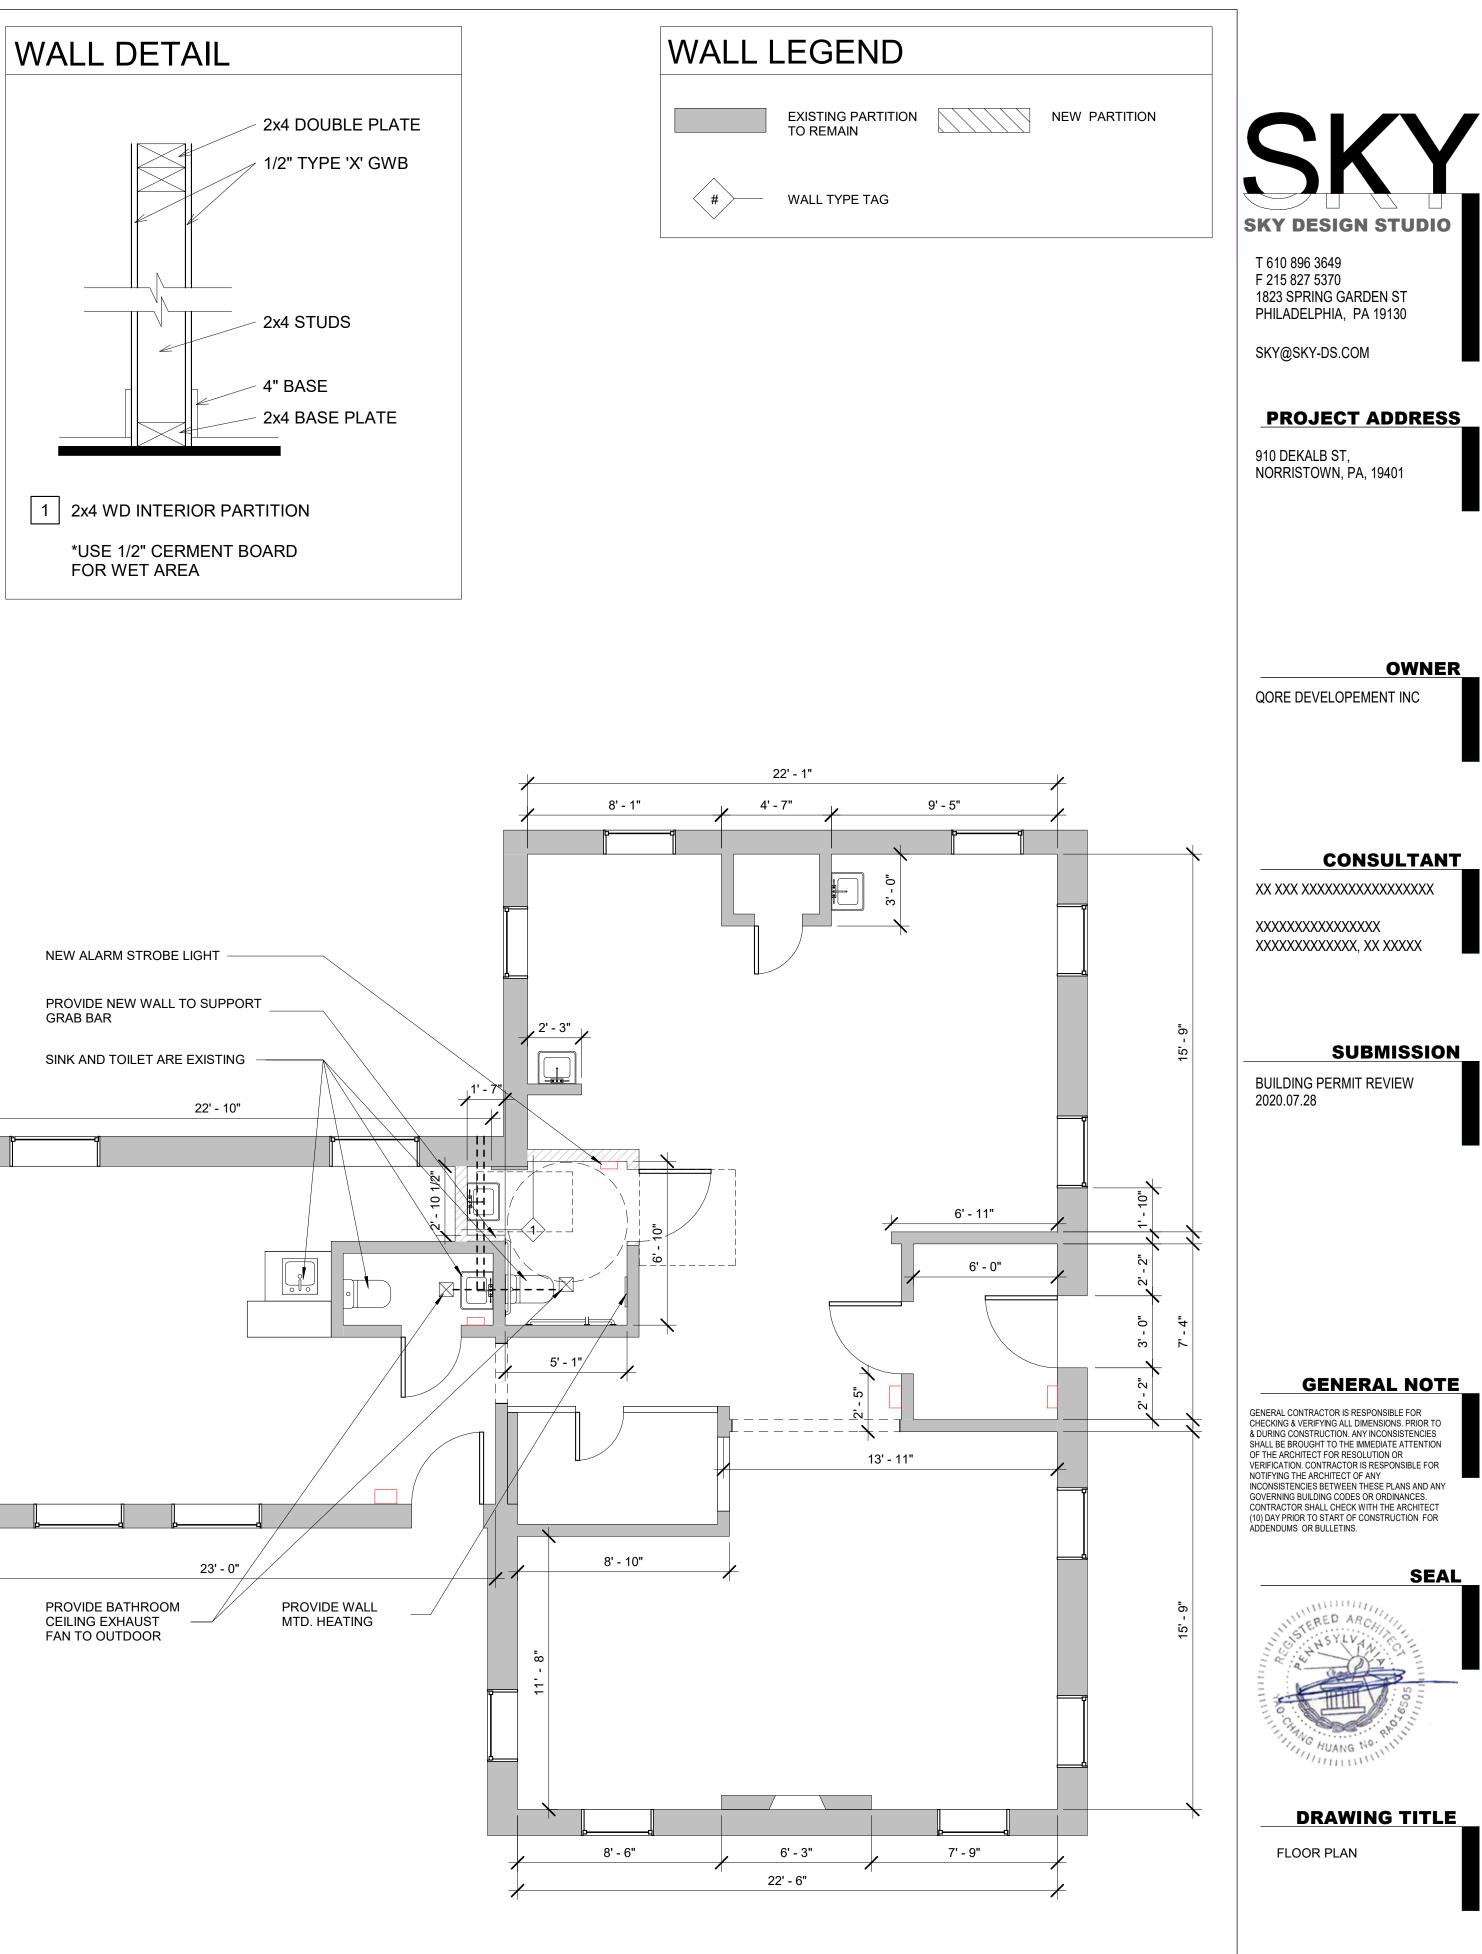




ADA GUIDELINES

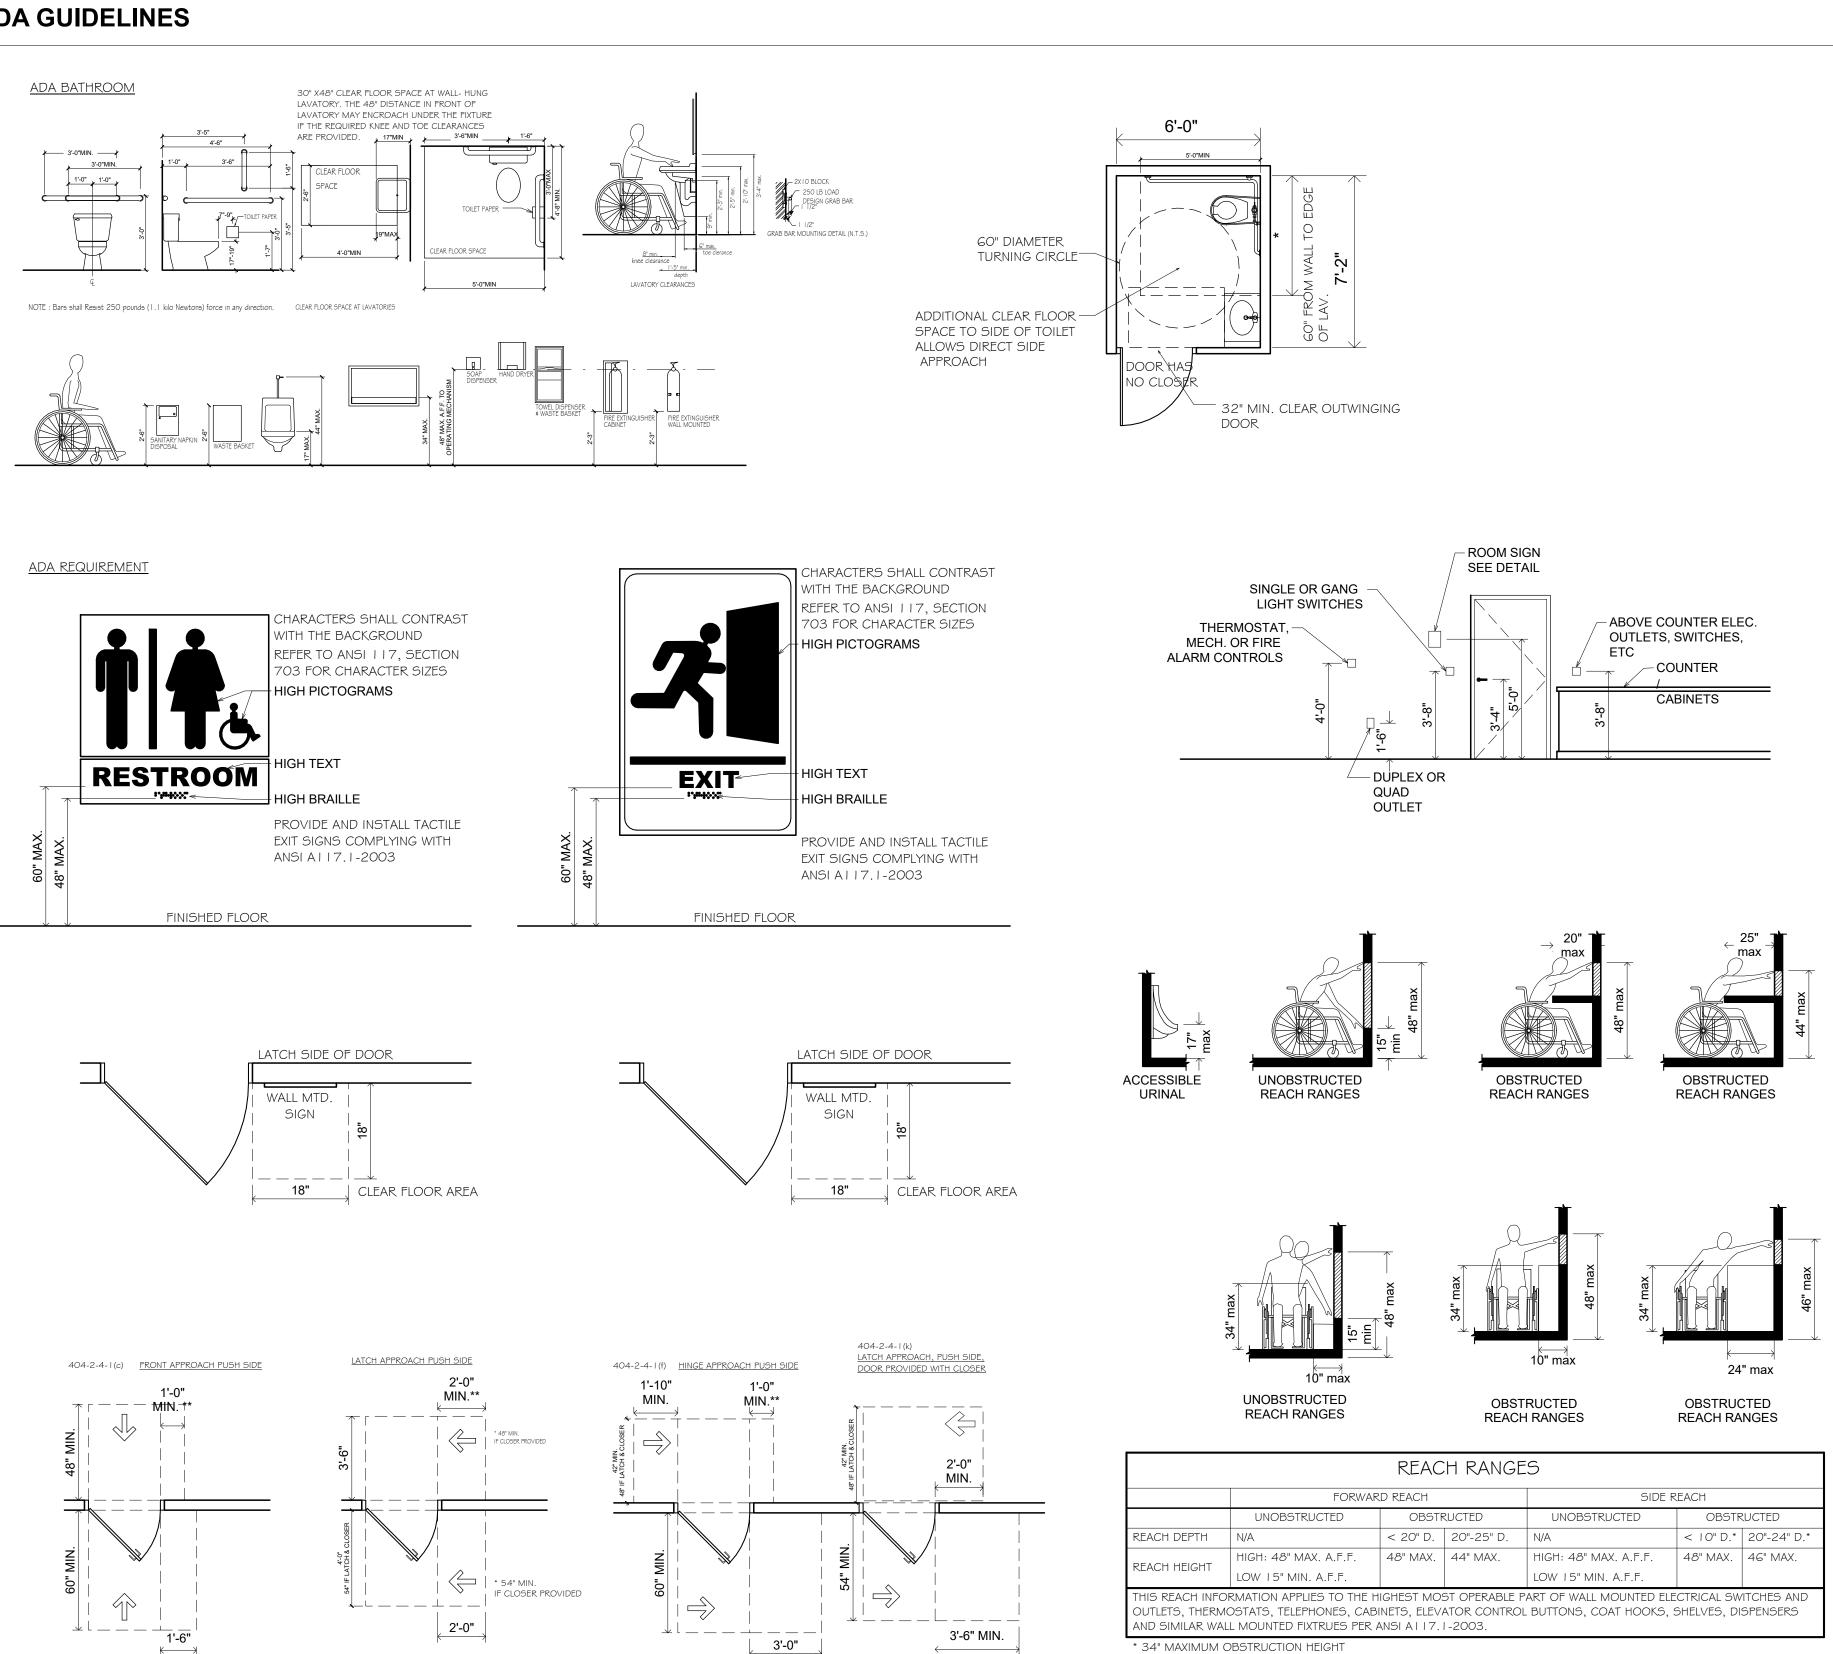


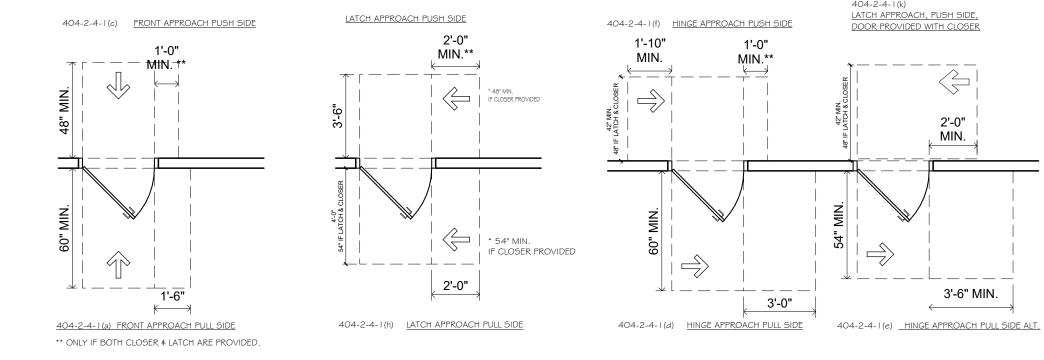



** ACCESSIBLE REACH RANGES SHALL BE VERIFIED AND COMPLY


WITH ANSI A 1 17.1-2003 SECTION308

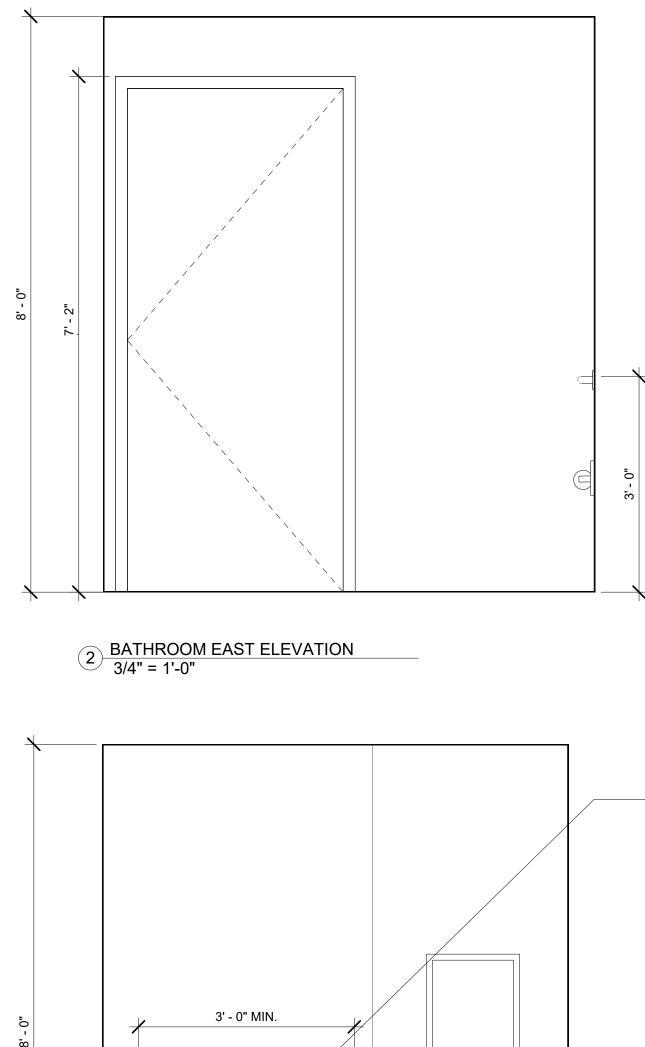

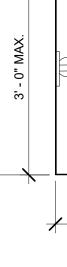

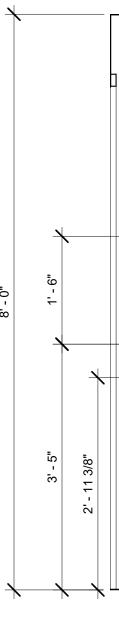

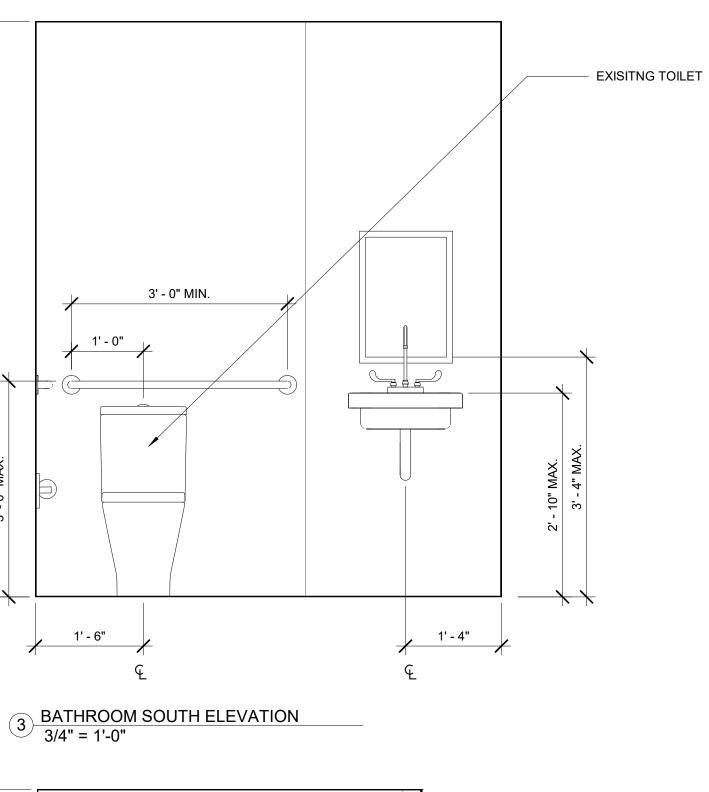

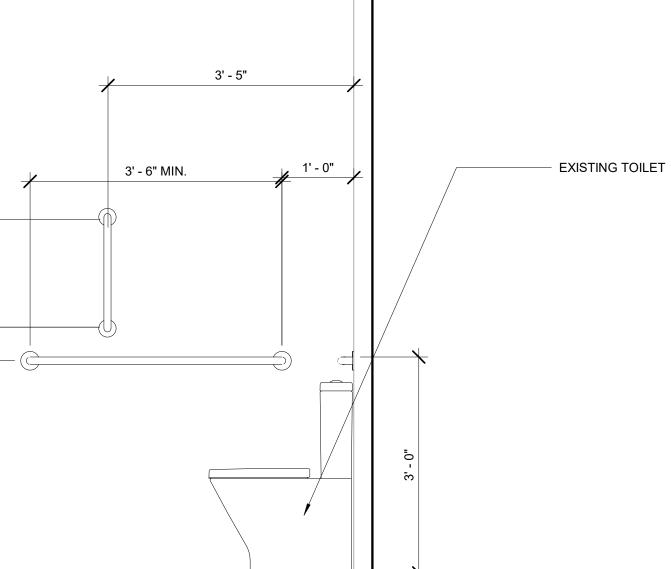

4 BATHROOM WEST ELEVATION 3/4" = 1'-0"



PROJECT ADDRESS

T 610 896 3649 F 215 827 5370 1823 SPRING GARDEN ST PHILADELPHIA, PA 19130

SKY@SKY-DS.COM

910 DEKALB ST, NORRISTOWN, PA, 19401 OWNER QORE DEVELOPEMENT INC CONSULTANT XX XXX XXXXXXXXXXXXXXXXXXXXXXXX XXXXXXXXXXXXXXXXXXXX XXXXXXXXXXXXX, XX XXXXX SUBMISSION BUILDING PERMIT REVIEW 2020.07.28 **GENERAL NOTE** GENERAL CONTRACTOR IS RESPONSIBLE FOR GENERAL CONTRACTOR IS RESPONSIBLE FOR CHECKING & VERIFYING ALL DIMENSIONS. PRIOR TO & DURING CONSTRUCTION. ANY INCONSISTENCIES SHALL BE BROUGHT TO THE IMMEDIATE ATTENTION OF THE ARCHITECT FOR RESOLUTION OR VERIFICATION. CONTRACTOR IS RESPONSIBLE FOR NOTIFYING THE ARCHITECT OF ANY INCONSISTENCIES BETWEEN THESE PLANS AND ANY GOVERNING BUILDING CODES OR ORDINANCES. CONTRACTOR SHALL CHECK WITH THE ARCHITECT (10) DAY PRIOR TO START OF CONSTRUCTION FOR ADDENDUMS OR BULLETINS. SEAL DRAWING TITLE ADA GUIDELINE / BATHROOM ELEVATIONS DRAWING NUMBER

AU.

NOTES:

- FURNISH ALL NECESSARY LABOR, MATERIAL, EQUIPMENT, AND SUPERVISION REQUIRED FOR THE PROPER COMPLETION OF THE PLUMBING AND RELATED WORK, INCLUDING CONFORMANCE WITH LOCAL CODES, REGULATIONS AND STANDARDS. INSULATION AND ADHESIVE USED ON THIS PROJECT SHALL HAVE A FLAME SPREAD CLASSIFICATION OF
- NO MORE THAN 25 AND A SMOKE DEVELOPED RATING OF NOT MORE THAN 50. ALL PIPING PENETRATIONS OF FIRE RATED PARTITIONS SHALL BE SAFE OFF WITH AN APPROVED FIRE RATED SEALANT. ALL DOMESTIC PIPING SHALL BE INSULATED INCLUDING PIPING IN WALLS.
- CONTRACTOR SHALL CHECK AND VERIFY ALL DIMENSIONS AND CONDITIONS AT THE BUILDING SITE BEFORE INSTALLATION OF HIS WORK
- REFER TO ARCHITECTURAL DRAWINGS FOR EXACT LOCATIONS OF ALL EQUIPMENT AND FIXTURES. PROVIDE ACCESSIBLE CLEANOUTS AT THE BASE OF ALL SANITARY STACKS AND AT THE BASE OF ALL VERTICAL RAINWATER CONDUCTORS. DRAINAGE PIPING CLEANOUTS SHALL BE LOCATED IN UNFINISHED ROOMS, STORAGE ROOMS, CLOSETS, AND JANITORS 8.
- CLOSETS WHERE POSSIBLE. EXTEND FLOOR CLEANOUTS FROM MAIN DRAIN TO THESE ROOMS. CLEANOUT LOCATIONS IN FINISHED ROOMS ARE TO BE SUBMITTED TO ARCHITECT FOR REVIEW PRIOR TO INSTALLATION. ALL CLEAN-OUTS SHALL MATCH THE FLOOR TYPE WHERE INSTALLED.
- 10. CONNECT ALL VENT STACKS TO BASE OF SOIL STACKS.
- PLUMBING CONTRACTOR SHALL VERIFY LOCATION AND INVERT ELEVATION OF EXISTING DRAINAGE PIPING BEFORE 11. PROCEEDING WITH NEW DRAINAGE PIPING INSTALLATION.
- 12. ALL DIMENSIONS AND EXISTING CONDITIONS SHALL BE CHECKED AND VERIFIED BY THE CONTRACTOR AT THE SITE BEFORE PROCEEDING WITH ANY WORK. 13. INSTALLING CONTRACTOR TO PROVIDE 1/8" SCALE SHOP DRAWINGS. COORDINATE ALL PIPING LOCATIONS IN ACCORDANCE
- WITH ARCHITECURAL PLANS. 14 PRIOR TO THE START OF WORK, CONTRACTOR SHALL SUBMIT TO ENGINEER THE FOLLOWING FOR REVIEW:
- A) LOCATIONS AND CONCEPTUAL DETAILS OF SUPPORTS, INCLUDING METHODS OF ATTACHMENT TO STRUCTURAL COMPONENTS. B) MAGNITUDES AND DIRECTIONS OF LOADS ANTICIPATED, STRUCTURAL ATTACHMENT POINTS UNDER ALL OPERATING
- CONDITIONS OF PIPING SYSTEM. C) SEISMIC CONFORMANCE TO LOCAL REQUIREMENTS INCLUDING 2009 IBC.
- D) ALL WORK SHALL BE IN COMPLIANCE WITH APPLIABLE CODES LISTED ON ARCHITECTURAL COVER SHEET. 15. ALL EXCAVATION SHALL BE PERFORMED IN STRICT COMPLIANCE WITH THE REGULATIONS OF [OSHA] THE OCCUPATIONAL SAFETY AND HEALTH ASSOCIATION.
- 16. PIPING TO BE INSTALLED IN ACCESSIBLE AREAS. IN CASES WHERE THE PIPING WILL BE EXTENDED THROUGH A SUPPORTING WALL, PERMANENT CEILING OR FLOOR, SLEEVES MUST BE INSTALLED.
- PLUMBING PIPING SHALL NOT BE RUN THROUGH ELECTRICAL ROOMS, TELECOMMUNICATION ROOMS, OR ELEVATOR 17 MACHINE ROOMS. EXCEPT FOR BRANCH PIPING SERVING EQUIPMENT IN THESE ROOMS. 18. UNLESS NOTED OTHERWISE ALL DRAINAGE PIPING SHALL HAVE A 0.01 SLOPE EXCEPT PIPING 3" AND SMALLER WHICH SHALL
- HAVE A 0.02 SLOPE. 19. ALL UNDERGROUND WASTE PIPING SHALL BE 2" MINIMUM.
- ALL FLOOR DRAINS SHALL BE PROVIDED WITH A TRAP PRIMER CONNECTION. PROVIDE A 1/2" COPPER LINE EXTENDED FROM 20. TRAP PRIMER AS SPECIFIED TO THE PRIMER CONNECTION. 21. ALL PIPING SYSTEMS SHALL HAVE VALVES AT POINTS SHOWN ON THE DRAWINGS AND/OR AS REQUIRED FOR ISOLATION OF
- EQUIPMENT AND FIXTURES. 22. SHUT-OFF VALVES CAPABLE OF 100 PERCENT DEAD SHUT-OFF SHALL BE PROVIDED ON EACH BRANCH LINE FROM THE MAIN AND BE INSTALLED FOR ALL EQUIPMENT AND PLUMBING FIXTURES TO PERMIT ISOLATION FOR MAINTENANCE AND REPAIR. 23. PROVIDE ISOLATION VALVES AT ALL CONNECTIONS TO RISERS, BRANCH PIPING AND TO ISOLATE INDIVIDUAL FIXTURES.
- 24. INSTALL VALVES WITH NEAT APPEARANCE AND ACCESSIBILITY. 25. CONNECTIONS SHALL BE MADE TO INSURE UNRESTRICTED CIRCULATION WITH NO AIR POCKETS OF TRAPPED CONDENSATE. DISCHARGE LINES FROM ALL RELIEF VALVES SHALL BE PIPED TO WITHIN FOUR INCHES (4") OF FLOOR DRAINS. 26. 27. SAFETY VALVES SHALL BE PIPED TO ATMOSPHERE IN ACCORDANCE WITH GOVERNING CODES, INCLUDING ALL SAFETY
- MEASURES RELATED TO PROPER OPERATION. 28. BACK FLOW PREVENTORS TO BE INSTALLED AS REQUIRED PER CODE OR AS REQUIRED PER MANUFACTURER'S
- INSTALLATION INSTRUCTIONS. 29. ALL DOMESTIC HOT WATER RETURN BRANCH CONNECTIONS SHALL BE EQUIPPED WITH A BALL VAVE, CHECK VALVE, AND
- BALANCING VALVE. 30. ALL PIPING SHALL BE SUPPORTED AT 4'-0" ON CENTER BOTH HORIZONTALLY AND VERTICALLY.
- 31. INSTALLING CONTRACTOR SHALL SUPPLY ALL PLUMBING FIXTURES, CARRIERS, AND ASSOCIATED TRIM.
- 32. PROVIDE DIELECTRIC UNIONS AT ALL CONNECTIONS BETWEEN DISSIMLAR MATERIALS. 33. PROVIDE SHOP DRAWINGS PRIOR TO START OF WORK.
- 34. PLUMBING CONTRACTOR SHALL COORDINATE HIS WORK WITH THE WORK OF ALL OTHER CONTRACTORS PRIOR TO START OF PLUMBING SYSTEM INSTALLATION.
- 35. ALL DRAIN GRATES, CLEANOUT COVERS, AND OTHER FINISH-EXPOSED COMPONENTS SHALL BE PROTECTED FROM DAMAGE. DAMAGED COMPONENTS SHALL BE REPLACED BY CONTRACTOR AT NO ADDITIONAL COST TO CONTRACT. 36. SCHEDULE ALL SHUTDOWNS THAT AFFECT UTILITIES AND PORTIONS OF THE BUILDING THAT MUST REMAIN IN OPERATION WITH THE OWNER.
- 37. DEMOLITION WORK AT ALL TIMES SHALL BE SUBJECT TO THE DIRECTION AND APPROVAL OF THE OWNER AND BE CARRIED OUT IN SUCH A MANNER SO AS NOT TO INTERFERE WITH THE NORMAL OPERATION OF THE BUILDING. 38. DISPOSE OF ALL REMOVED MATERIAL IN APPROVED MANNER.
- 39. ISOLATE, DRAIN, AND REFILL EXISTING SYSTEMS AS REQUIRED TO ACCOMMODATE INSTALLATION OF NEW SYSTEMS. 40. PROVIDE ALL NECESSARY TEMPORARY OR PERMANENT CAPS OR PLUGS FOR PIPING. DO NOT LEAVE PIPING OPEN ENDED. 41. EQUIPMENT AND MATERIALS DESIRED BY THE OWNER SHALL BE STORED AT THE SITE BY THE COTNRACTOR AT A LOCATION DIRECTED BY THE OWNER. EQUIPMENT AND MATERIALS NOT DESIRED BY THE OWNER SHALL BE REMOVED FROM THE SITE BY THE CONTRACTOR IMMEDIATELY.
- 42. REMOVE AND/OR RELOCATE EXISTING EQUIPMENT AS SPECIFIED OR SHOWN ON THE DRAWINGS IN A NEAT AND WORKMANLIKE MANNER. HANGERS, FOUNDATIONS AND/OR STRUCTURAL SUPPORTS FOR SAID EQUIPMENT AND MATERIALS SHALL BE REMOVED.
- 43. NO EXISTING EQUIPMENT OR MATERIAL SHALL BE REUSED WITHOUT SPECIFIC APPROVAL OF THE OWNERS REPRESENTATIVE.
- 44. ALL EQUIPMENT AND MATERIAL TO BE REMOVED THAT IS DESIRED BY THE OWNER SHALL BE RIGGED TO AN ONSITE STORAGE LOCATIONS AS DIRECTED BY THE OWNER.
- 45. ALL WATER HAMMER ARRESTORS SHALL BE LOCATED IN AN ACCESSIBLE LOCATION AS REQUIRED BY CODE. PROVIDE ACCESS PANELS AS NEEDED.
- 46. ALL WORK SHALL BE INSTALLED IN ACCORDANCE WITH THE 2015 INTERNATIONAL PLUMBING CODE AND ALL OTHER APPLICABLE CODES. 47. CAP ALL UNUSED PIPING BEHIND FINISHED SURFACES AS REQUIRED TO ACCOMMODATE NEW WORK.
- 48. STERILIZE THE WATER DISTRIBUTION SYSTEM BY THE METHODS APPROVED BY THE AUTHORITY HAVING JURISDICTION.
- 49. TEST THE SANITARY PIPING THROUGHOUT UPON COMPLETION OF ROUGH-IN TESTING SHALL BE IN COMPLIANCE WITH 2015 INTERNATIONAL AND LOCAL PLUMBING CODE. 50. TEST THE DOMESTIC HOT & COLD WATER PIPING WITH A HYDROSTATIC PRESSURE. TESTING SHALL BE IN COMPLIANCE WITH
- 2015 INTERNATIONAL AND LOCAL PLUMBING CODE. THIS PROJECT NEITHER OVERLOADS ANY EXISTING SYSTEM NOR CREATES/INCREASES ANY CODE NONCONFORMITY.
- 52. ALL PIPING TO BE LABELED EVERY 15' MAX OR AT ALL CHANGES OF DIRECTION AND WHERE PIPING PASSES THROUGH A WALL. CONTRACTOR TO PROVIDE A VALVE TAG CHART.
- 53. ALL DOMESTIC WATER VALVES TO BE LEAD FREE.

HOT WATER HEATER

RE A GEN	SYMBOL LIST AND FIRE PROTECTION ABBREV NERAL LIST OF SYMBOLS AND ABBREVIATIONS. AR AS PART OF PROJECT DOCUMENTS.	
LUM	BING ABBREVIATIONS	PLUMBING SYMBOLS
OFCI	OWNER FURNISHED CONTRACTOR INSTALLED	
CLG	CEILING	
DN	DOWN	(E) EXISTING
UNO	UNLESS NOTED OTHERWISE	O PIPE UP
VIF	VERIFY IN FIELD	C PIPE DOWN
(RE)	RELOCATE EXISTING	
AFF	ABOVE FINISHED FLOOR	-DX- GLOBE VALVE
(E)	EXISTING TO REMAIN	
MFG	MANUFACTURER	BALL VALVE
GPM	GALLONS PER MINUTE	
ENT	ENTERING	->- DIRECTION OF FLOW
LVG	LEAVING	
NO.	NUMBER	
/-PH-HZ	VOLTAGE-PHASE-HERTZ	M METER
HP	HORSEPOWER	SANITARY PIPING
#	NUMBER	
HD FT	DYNAMIC HEAD IN FEET OF WATER	· · DOMESTIC COLD WATER
PD	PRESSURE DROP IN INCHES OF WATER	DOMESTIC HOT WATER
PD FT	PRESSURE DROP IN FEET OF WATER	
°F	DEGREES FAHRENHEIT	DOMESTIC HOT WATER RETURN
W/	WITH	FW FILTERED WATER
@	AT	TWTEMPERED WATER
FLR	FLOOR	FP
TYP	TYPICAL	ST STORM SYSTEM PIPING
RD	ROOF DRAIN	— G — GAS PIPING
INT	INTERNAL TRAP	— C — CONDENSATE DRAIN PIPING
EWT	ENTERING WATER TEMPERATURE	CG COMPRESSED GAS PIPING
LWT	LEAVING WATER TEMPERATURE	CONNECT TO EXISTING VERIFY LOCATION IN FIELD
XXX	REFER TO EQUIPMENT VENDOR	C.O. C.O. CLEAN OUT
R	RISER IDENTIFICATION	

NOTE: ANY EQUIPMENT NOTED AS "RELOCATE EXISTING" DAMAGED BY CONTRACTOR SHALL BE REPLACED IN KIND AT NO COST TO OWNER

UNIT NO.	DIMENSIONS	GAL	RECOVERY GPH AT 90°F	WATTAGE & AMP	MFG/MODEL (NOTE 1)	ACCESSORIES			
HWH-1	24" DIAMETER	ER 80	21	4.5 kW	BRADFORD WHITE RE350S8	T AND P RELIEF VALVE TO DRAIN PAN. SYSTEM EXPANSION TANK WATTS PLT-20. PROVIDE DRAIN PAN FOR HOT WATER HEATER. COORDINATE ELECTRICAL CONNECTIONS.			
NOTE 1: 0	CONTRACTOR T	O CONFIRM	I WITH OWNER F	RIOR TO OR	DER.				
							PIPINC	GLEGEND	
S	YMBOL	SEI	RVICE		SIZE	MATERIAL	JOINTS	INSULATION	
	сw — с	OMESTIC	COLD WATER		ALL	PEX	PUSH-FIT	-	JOINTS SHALL C

SYMBOL	SERVICE	SIZE	MATERIAL	JOINTS	INSULATION	
— cw —	DOMESTIC COLD WATER	ALL	PEX	PUSH-FIT	-	JOINTS SHALL CO
— HW —	DOMESTIC HOT WATER	ALL	PEX	PUSH-FIT	-	JOINTS SHALL CO
— cw —	DOMESTIC COLD WATER	ALL	COPPER TYPE "L" HARD	SOLDERED	3/4" FIBERGLASS	
— HW —	DOMESTIC HOT WATER	ALL	COPPER TYPE "L" HARD	SOLDERED	1" FIBERGLASS	
— s —	SANITARY	LESS THAN OR EQUAL 2-1/2"	SCHEDULE 40 SOLID CORE PVC	SOLVENT-CEMENT	-	SOLVENT CEMENT
— s —	SANITARY	GREATER THAN 2-1/2"	SCHEDULE 40 SOLID CORE PVC	SOLVENT-CEMENT	-	SOLVENT CEMENT
— v —	VENT	LESS THAN OR EQUAL 2-1/2"	SCHEDULE 40 SOLID CORE PVC	SOLVENT-CEMENT	-	SOLVENT CEMENT
— v —	VENT	GREATER THAN 2-1/2"	SCHEDULE 40 SOLID CORE PVC	SOLVENT-CEMENT	-	SOLVENT CEMENT
— s —	SANITARY	LESS THAN OR EQUAL 2-1/2"	COPPER TYPE "L" HARD	SOLDERED	-	
— s —	SANITARY	GREATER THAN 2-1/2"	CAST IRON	CAULKED JOINTS	-	
— v —	VENT	LESS THAN OR EQUAL 2-1/2"	COPPER TYPE "L" HARD	SOLDERED	-	
— v —	VENT	GREATER THAN 2-1/2"	CAST IRON	CAULKED JOINTS	-	
— c —	CONDENSATE	ALL	SCHEDULE 40 SOLID CORE PVC	SOLVENT-CEMENT	1/2" FIBERGLASS	SOLVENT CEMENT

PIPE SIZE

IN

PIPE ROD

1/2 - 2 3/8

IN

w vent drain		
w vent drain		
	WSFU	DFU
2" 3"	3	4
/2" 1-1/2" 1-1/2"	2	2
/2" 1-1/2" 1-1/2"	2	2
_	" 1-1/2" 1-1/2"	" 1-1/2" 1-1/2" 2

GENERAL NOTES-REFER TO ARCHITECTURAL PLANS

- 1 CONTRACTOR TO VERIFY ALL ELEVATIONS AND MILLWORK WITH ARCHITECTURAL DRAWINGS PRIOR TO START OF WORK.
- 2 CONTRACTOR TO REFER TO ARCHITECTURAL DRAWINGS FOR ELEVATIONS, MOUNTING HEIGHTS & SPECIFICATIONS.
- 3 CONTRACTOR TO REFER TO ARCHITECTURAL DRAWINGS FOR WALL AND FLOOR RATINGS.

MATERIAL:

1. ABOVE GROUND VENT AND DRAINAGE PIPING SHALL BE SOLID WALL PVC. PVC SOCKET FITTINGS, AND SOLVENT CEMENTED JOINTS. MECHANICAL JOINT ARE PROHIBITED. PVC PIPING SHALL BE SUPPORTED AT A MAX. 4'-0" IN HORIZONTAL SPACING AND A MAX. 10'-0" IN VERTICAL SPACING.

2. UNDER GROUND VENT AND DRAINAGE PIPING SHALL BE SERVICE WEIGHT HUB AND SPIGOT CAST IRON CONFORMING TO ASTM A74, WITH LEAD AND OAKUM CAULKED JOINTS PER THE PHILADELPHIA PLUMBING CODE. MECHANICAL JOINT ARE PROHIBITED FOR UNDERGROUND APPLICATION.

3. METALLIC TO PLASTIC PIPE MUST BE MADE AFTER THE FIRE RATED ASSEMBLY, JOINT BETWEEN PLASTIC AND CAST-IRON HUB PIPE SHALL BE MADE BY A CAULKED JOINT OR A MECHANICAL COMPRESSION JOINT. JOINT BETWEEN PLASTIC PIPE AND CAST-IRON HUBLESS PIPE SHALL BE MADE BY MECHANICAL JOINT OF COMPRESSION OR MECHANICAL SEALING TYPE.

4. PEX PIPING AS ALLOWED PER THE PHILADELPHIA PLUMBING CODE AND AUTHORITY HAVING JURISDICTION. PEX PIPE SHALL BE SUPPORTED AT A MAX. 32" IN HORIZONTAL SPACING AND A MAX. 10'-0" IN VERTICAL SPACING. A GUIDE SHALL BE INSTALLED MIDWAY BETWEEN VERTICAL SUPPORTS TO PREVENT PIPE MOVEMENT IN A DIRECTION PERPENDICULAR TO THE AXIAL OF THE PIPE.

5. PIPING OUTSIDE OF THE INDIVIDUAL DWELL UNITS SHALL BE ASTM B88 TYPE "L" COPPER TUBE WITH WROUGHT OR CAST COPPER FITTING AND LEAD FREE SOLDERED JOINTS. SOLDER JOINTS SHALL BE MADE IN ACCORDANCE WITH THE METHOD OF ASTM B828, COPPER PIPING SHALL BE SUPPORTED AT A MAX. 12'-0" IN HORIZONTAL SPACING AND A MAX. 10'-0" IN VERTICAL SPACING.

6. JOINT BETWEEN PLASTIC PIPE AND COPPER SHALL BE MADE BY A MECHANICAL JOINT OF COMPRESSION OR MECHANICAL SEALING TYPE PER THE PHILADELPHIA PLUMBING CODE AND AUTHORITY HAVING JURISDICTION.


NOTES TO BIDDERS: 1. ALL PARTIES USING THESE DOCUMENTS SHALL VERIFY AND BE RESPONSIBLE FOR ALL FIELD DIMENSIONS AND CONDITIONS PRIOR TO PREPARATION OF SPACE PLANNING OR CONSTRUCTION DOCUMENTATION, OR ACTUAL CONSTRUCTION OF ANY AREA. 2. PRIOR TO SUBMISSION TO BID, CONTRACTOR SHALL VISIT PROJECT SITE AND CAREFULLY EXAMINE EXISTING CONDITIONS AND COMPARE THEM WITH ISSUED PLANS. CONTRACTOR TO ADVISE ARCHITECT AND ENGINEERING OF ANY DISCREPANCIES. 3. SUBMITTAL OF BID SHALL INDICATE THAT CONTRACTOR HAS EXAMINED THE SITE, AND HAS INCLUDED ALL REQUIRED ALLOWANCES IN BID. NO ALLOWANCES SHALL BE MADE FOR ANY ERROR RESULTING FROM CONTRACTOR'S FAILURE TO VISIT JOB SITE. MLL WORK SHALL BE INSTALLED IN COMPLIANCE WITH: "THE WEST NORRITON TOWNSHIP CODE" OF 2002 2015 INTERNATIONAL BUILDING CODE (IBC)	clients: IDSG llc.
2015 INTERNATIONAL ENERGY CONSERVATION CODE (IECC) 2015 INTERNATIONAL EXISTING BUILDING CODE (IEBC) 2015 INTERNATIONAL FIRE CODE (IFC) 2015 INTERNATIONAL FUEL GAS CODE (IFGC) 2009 INTERNATIONAL PERFORMANCE CODE (ICCPC) 2015 INTERNATIONAL PLUMBING CODE (IPC) 2015 INTERNATIONAL MECHANICAL CODE (IMC) 2009 INTERNATIONAL ELECTRICAL CODE (IEC) 2015 INTERNATIONAL ENERGY CONSERVATION CODE (IECC) 2015 INTERNATIONAL ENERGY CONSERVATION CODE (IECC) 2015 INTERNATIONAL WILDLAND-URBAN INTERFACE CODE (IWUIC) 2009 ANSI A 117.1 (ADA)	Integrated Design Solution Group, LLC ENGINEERS OF MECHANICAL, PLUMBING & ELECTRICAL SYSTEMS. 444 E. TOWNSHIP LINE RD. PO BOX 1467 HAVERTOWN, PA 19083 484-450-6054 integrated design solution. IIc@gmail.com
	ANDREW J. SILVESTRE, PE PA PROFESSIONAL ENGINEER NO. PE084363
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INSERT AS MFG. BY F & S MANUFACTURING CORP. OR APPROVED EQUAL FIG. N. 80A-3/8" TO 3/4" ROD FIG. N. 80B-7/8" DIA. ROD

WITH INCOMPRESSIBLE INSULATING BLOCK AT HANGER					
PIPE SIZE IN	SHIELD LENGTH IN	SHIELD THICKNESS USSG			
UP TO 3	6	18			
4 TO 6	8	16			
& LARGER	12 16				
WITHOUT INCOMPRESSIBLE INSULATING BLOCK AT HANGER					
PIPE SIZE IN					
UP TO 3	12	18			
4	15	16			
5	18	16			
6	21	16			
& LARGER	24	14			

REMARKS

CONFORM TO ASSE 1061 AND INSTALLED IN ACCORDANCE WITH MANUFACTURER'S INSTRUCTIONS CONFORM TO ASSE 1061 AND INSTALLED IN ACCORDANCE WITH MANUFACTURER'S INSTRUCTIONS

NT NOT PURPLE IN COLOR SHALL CONFORMS TO ASTM D2564, CSA B137.3, CSA B181.2 OR CSA B182.1 NT NOT PURPLE IN COLOR SHALL CONFORMS TO ASTM D2564, CSA B137.3, CSA B181.2 OR CSA B182.1 NT NOT PURPLE IN COLOR SHALL CONFORMS TO ASTM D2564, CSA B137.3, CSA B181.2 OR CSA B182.1 INT NOT PURPLE IN COLOR SHALL CONFORMS TO ASTM D2564, CSA B137.3, CSA B181.2 OR CSA B182.1

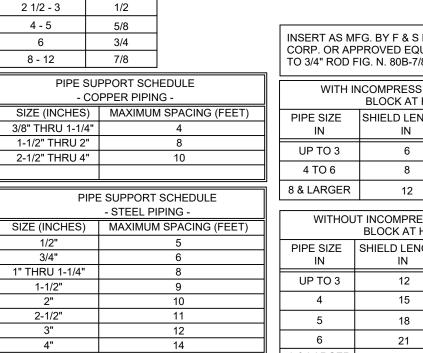
INSTALL PER SECTION 705.3 OF THE 2015 IPC


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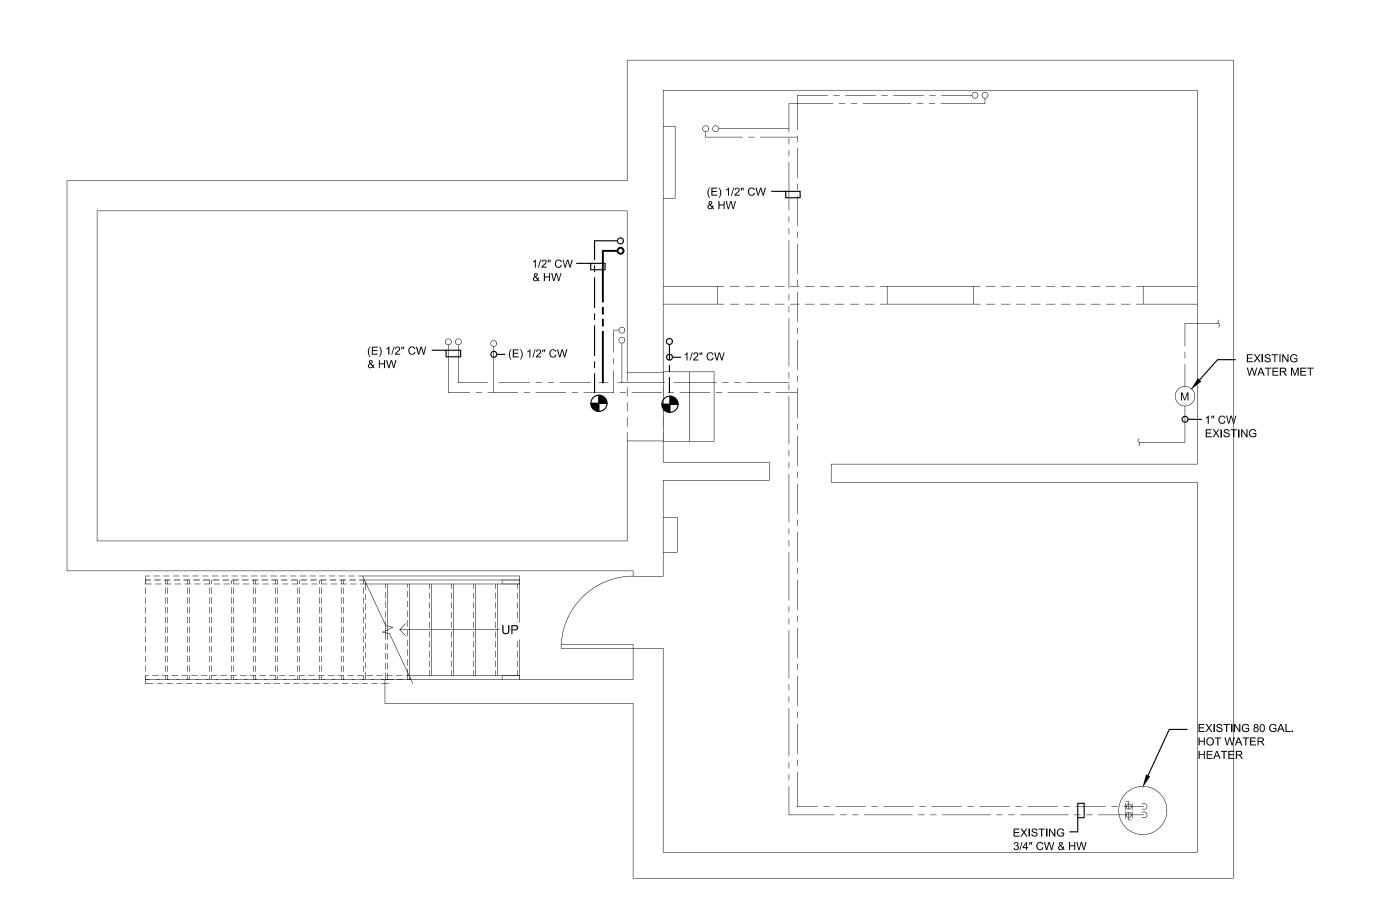
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NT NOT PURPLE IN COLOR SHALL CONFORMS TO ASTM D2564, CSA B137.3, CSA B181.2 OR CSA B182.1








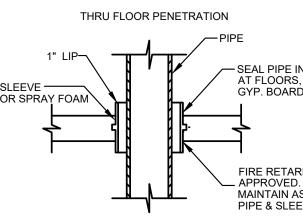


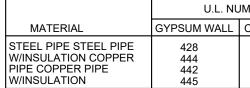1 BASEMENT - DOMESTIC WATER P1.0 SCALE: 1/4" =1'-0"

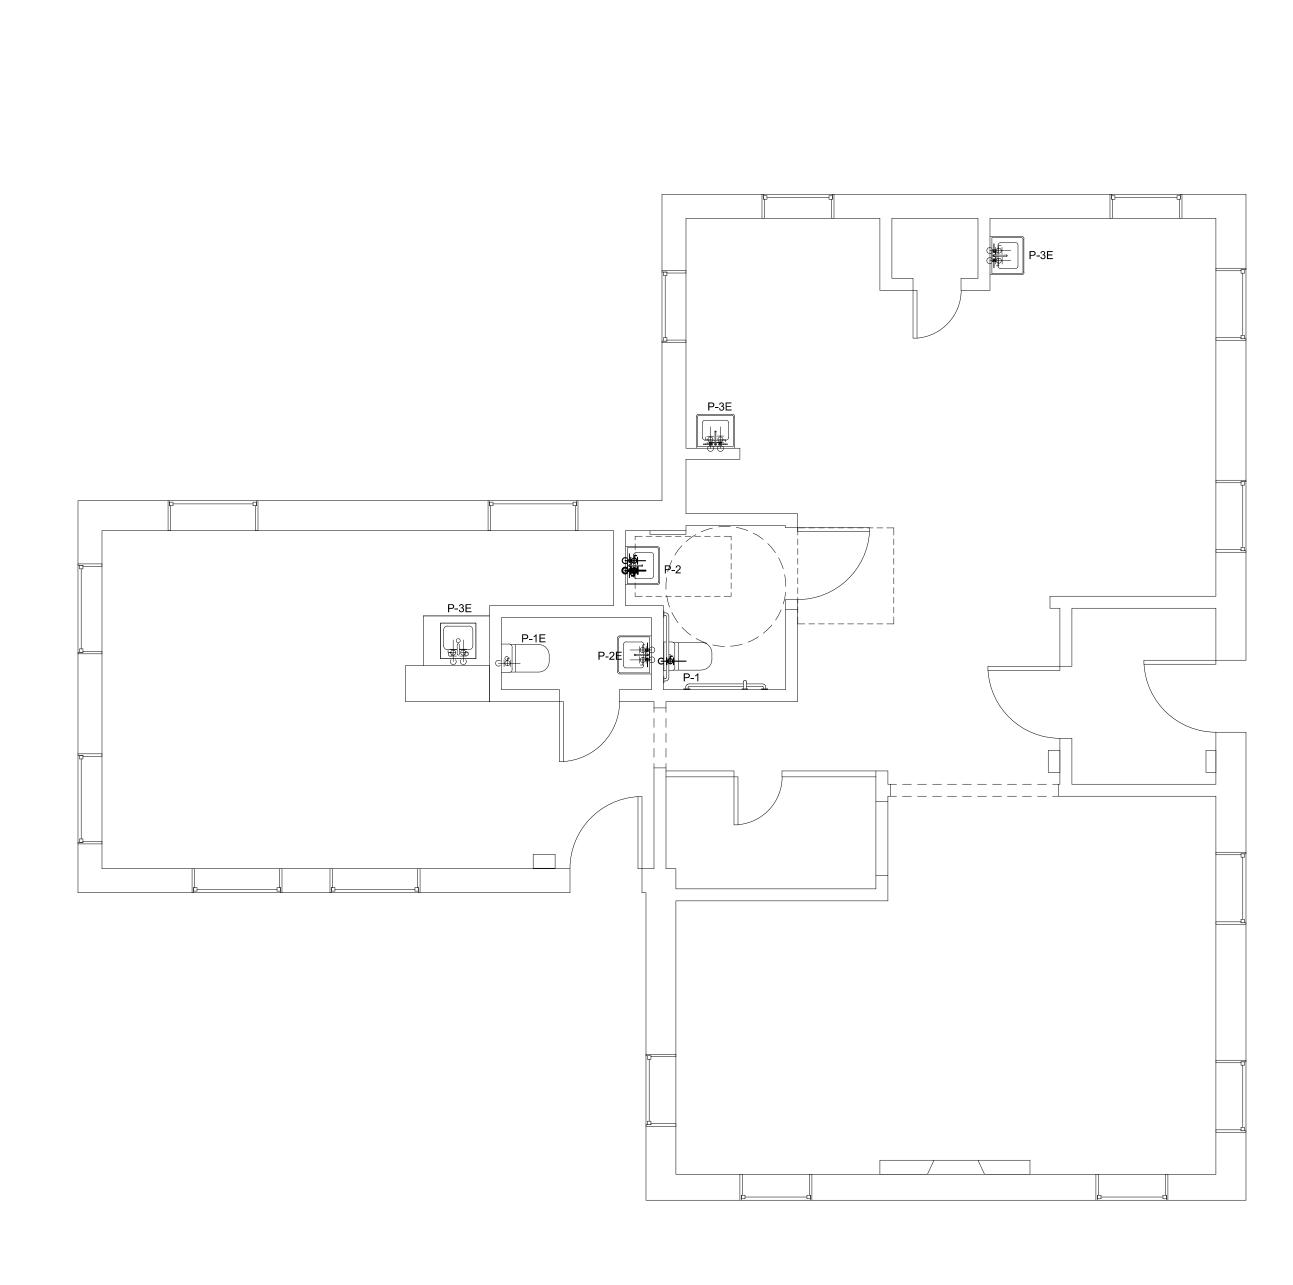


2 FIRST FLOOR - DOMESTIC WATER P1.0 SCALE: 1/4" =1'-0"

Clients:
IDSG IIC.
Integrated Design Solution Group, LLC ENGINEERS OF MECHANICAL, PLUMBING
& ELECTRICAL SYSTEMS. 444 E. TOWNSHIP LINE RD.
PO BOX 1467 HAVERTOWN, PA 19083 484-450-6054 integrateddesignsolution.llc@gmail.com
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ANDREW J. SILVESTRE, PE
ANDREW J. SILVESTRE, PE PA PROFESSIONAL ENGINEER NO. PE084363
Revisions:
Project:
INTERIOR RENOVATION
910 DEKALB ST
NORRISTOWN, PA 19401
Drawing Title: FLOOR PLANS
DOMESTIC WATER
Date:
Project No.:
Drawn By: Checked By:
Drawing Number:
P1.0

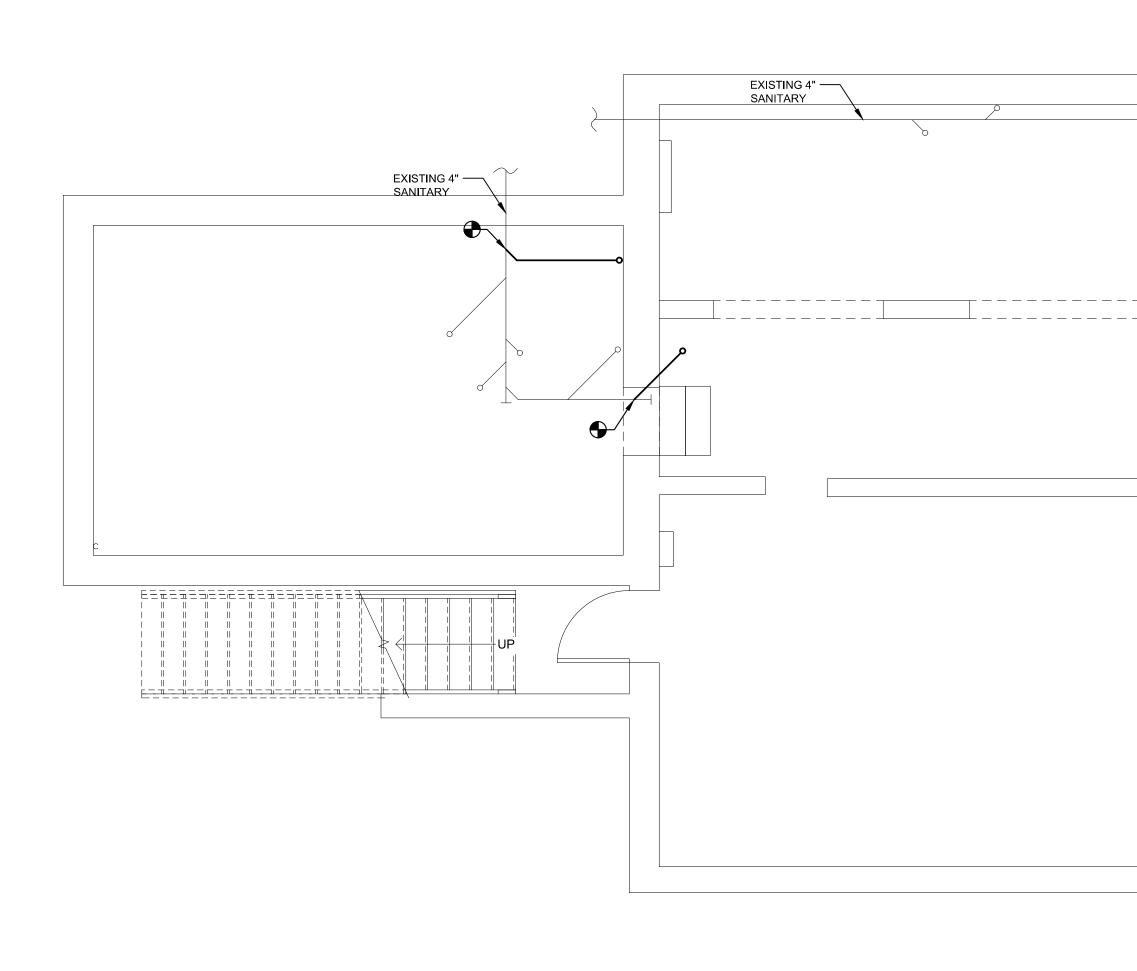



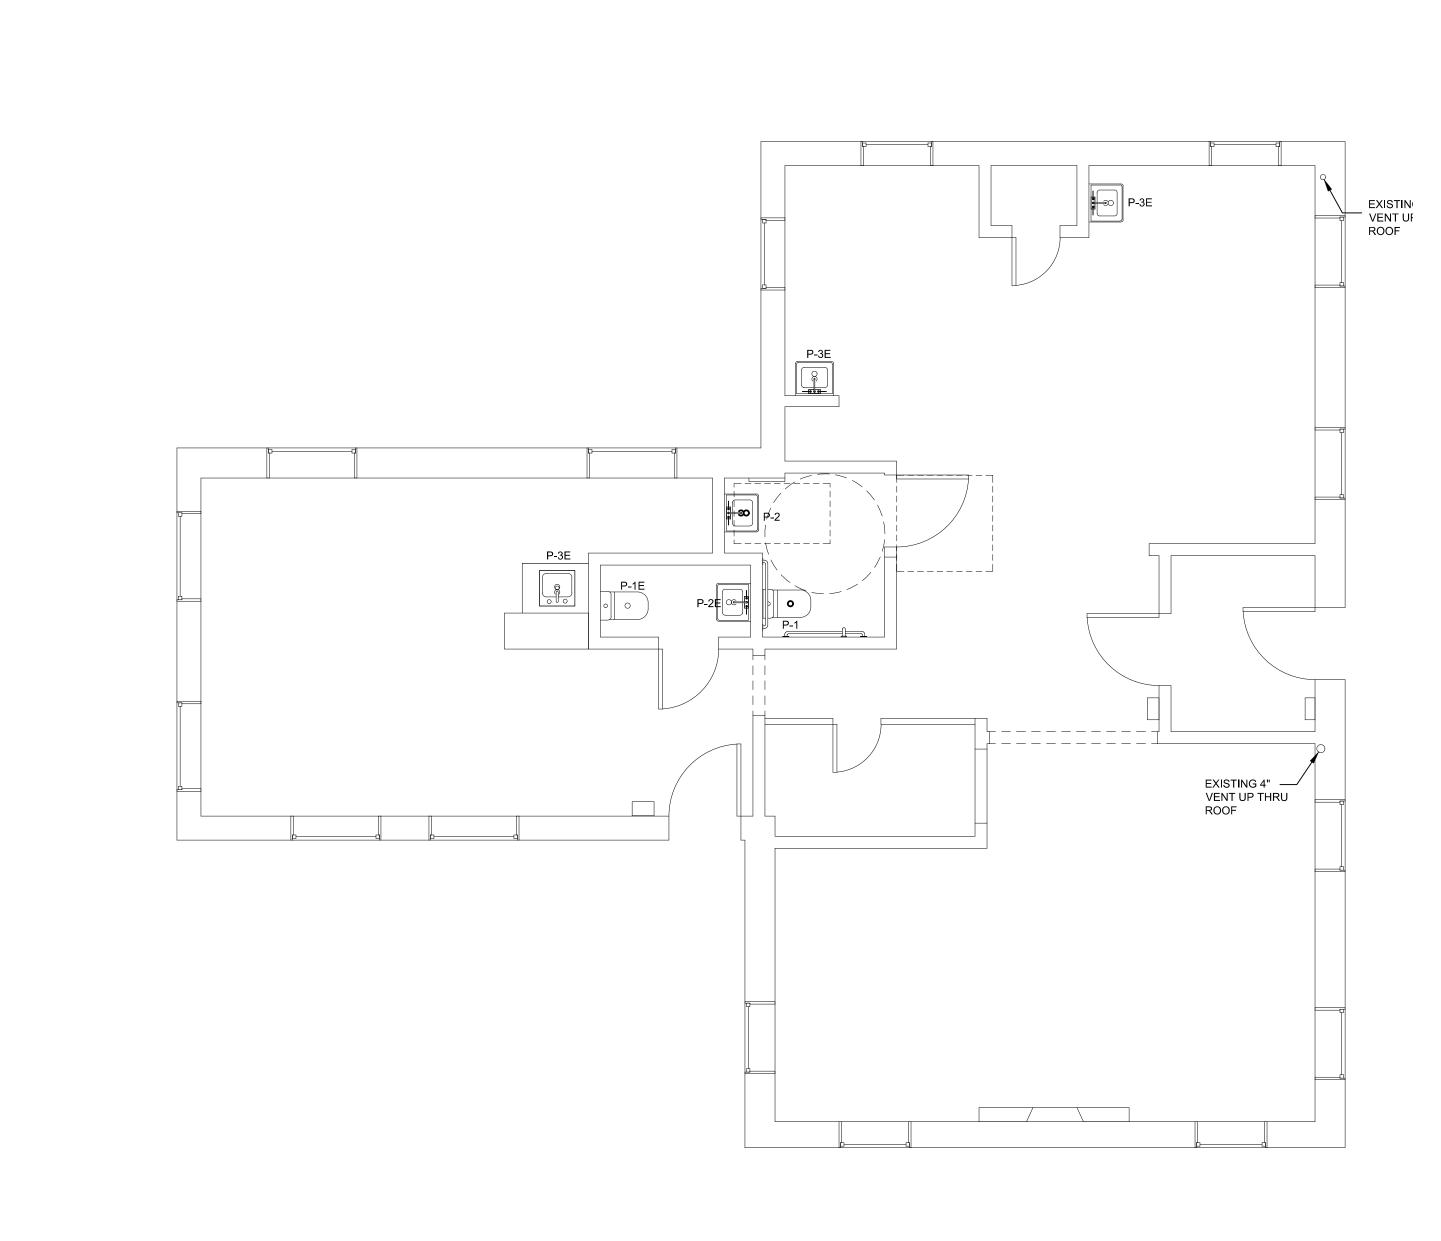



Clients:
Integrated Design Solution Group, LLC ENGINEERS OF MECHANICAL, PLUMBING & ELECTRICAL SYSTEMS. 444 E. TOWNSHIP LINE RD. PO BOX 1467 HAVERTOWN, PA 19083 484-450-6054
integrateddesignsolution.llc@gmail.com
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ANDREW J. SILVESTRE, PE PA PROFESSIONAL ENGINEER NO. PE084363
Revisions:
Project:
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910 DEKALB ST NORRISTOWN, PA 19401
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ELECTRICAL SPECIFICATIONS

1.01 CODES AND STANDARDS

- A) ALL WORK AND EQUIPMENT SHALL BE SYSTEMATICALLY, CAREFULLY AND NEATLY PERFORMED AND SHALL CONFORM TO THE FOLLOWING STANDARDS:
- 1. 2015 IBC
- 2014 NATIONAL ELECTRIC CODE PHILADELPHIA BUILDING CODE
- 4. UNDERWRITERS LABORATORIES, INC.(UL)
- 5. OSHA AND ALL AGENCIES HAVING JURISDICTION
- 1.02 SCOPE OF WORK
- A) FURNISH ALL LABOR, MATERIALS, TOOLS, EQUIPMENT, INSURANCE PERMITS, AND INSPECTIONS NECESSARY FOR THE COMPLETE INSTALLATION OF THE ELECTRICAL SYSTEMS AS SHOWN AND SPECIFIED. THE SCOPE OF WORK SHALL INCLUDE BUT IS NOT LIMITED TO THE FOLLOWING;
 - 1. UTILITY SERVICE PANELBOARDS AND DISCONNECTS
- LIGHTING AND POWER 4. TEMPORARY LIGHTING AND POWER DURING CONSTRUCTION.
- B) PROVIDE ONE YEAR WRITTEN GUARANTEE ON ALL WORK PERFORMED.
- C) CONTRACTOR SHALL PROVIDE ALL WORK NECESSARY FOR OBTAINING REQUIRED

1.03 RACEWAYS

PERMITS.

- A) RIGID GALVANIZED STEEL (RGS) CONDUIT SHALL CONFORM TO UL 6. FITTINGS SHALL BE THREADED.
- B) ELECTRICAL METALLIC TUBING (EMT) SHALL CONFORM TO UL 797. FITTINGS SHALL BE GLAND AND RING COMPRESSION TYPE.
- C) LIQUID TIGHT FLEXIBLE METAL CONDUIT SHALL CONFORM TO UL 360.
- D) MINIMUM RACEWAY SIZE SHALL BE 3/4". PROVIDE GROUNDING OF ALL RACEWAYS AS REQUIRED BY THE PHILADELPHIA ELECTRIC CODE.
- E) RACEWAY UTILIZATION SHALL BE AS FOLLOWS:
- 1. ELECTRICAL METALLIC TUBING (EMT) INTERIOR CONCEALED AND EXPOSED DRY LOCATIONS.
- 2. LIQUID TIGHT FLEXIBLE CONDUIT FINAL CONNECTIONS TO MOTORS MECHANICAL EQUIPMENT AND SYSTEMS FURNITURE.
- 3. ARMORED CABLE (MC OR AC WITH INSULATED GROUND CONDUCTOR) BRANCH CIRCUITING IN CONCEALED LOCATIONS ONLY. ROMEX CABLE WILL BE PERMITTED WHERE APPROVED BY LOCAL AUTHORITY AND NEC. TYPE 'SER' SERVICE CABLE WILL BE PERMITTED FOR CONNECTIONS TO PANELBOARDS WHERE APPROVED BY LOCAL AUTHORITY AND NEC.
- 4. RIGID NONMETALLIC CONDUIT WET LOCATIONS, INSTALLED AND EQUIPPED SO AS TO PREVENT WATER FROM ENTERING CONDUIT, ALL SUPPORTS, STRAPS, SCREWS, ETC., SHALL BE OF CORROSION RESISTANT MATERIAL OR PROTECTED BY CORROSION RESISTANT MATERIAL. DRY AND DAMP LOCATIONS. UNDERGROUND INSTALLATIONS.

1.04 BOXES

- A) OUTLET, PULL AND JUNCTION BOXES SHALL BE FABRICATED FROM STEEL AND CONFORM TO UL 50, UL 514 AND NEMA OS1. BOXES FOR INTERIOR LOCATIONS SHALL BE CODE GAUGE, GALVANIZED SHEET STEEL. PLASTIC BOXES WILL BE PERMITTED WHERE APPROVED BY LOCAL AUTHORITY AND NEC.
- BOXES SHALL BE SIZED AS REQUIRED BY CODE FOR NUMBER AND GAUGE OF CONDUCTORS THEREIN, EXCEPT WHERE NOTED TO BE LARGER, THE MINIMUM BOX SHALL BE 4" SQUARE BY 1-1/2" DEEP. COVERS GREATER THAN 50LB SHALL BE DIVIDED INTO MULTIPLE SECTIONS.
- C) WIREWAYS AND AUXILIARY GUTTERS SHALL BE TWO-PIECE STEEL CONSTRUCTION WITH ANSI 61 GRAY ENAMEL FINISH. COVERS SHALL BE SCREW-ON TYPE.

1.05 FASTENERS


- PROVIDE METALLIC EXPANSION SHIELDS AND MACHINE BOLTS, INSERTS, TOGGLE A) BOLTS, LAG SCREWS OR BOLTS, ANCHORS, BOLTS WITH NUTS AND WASHERS, SHIMS OR ANY OTHER TYPE OF FASTENING DEVICES REQUIRED TO FASTEN PANELS OR OTHER EQUIPMENT TO FLOORS, WALLS OR CEILINGS.
- 1.06 WIRES, CABLES, SPLICES AND TERMINATIONS
- A) POWER AND CONTROL WIRING SHALL BE COPPER, MINIMUM 98% CONDUCTIVITY, WITH TYPE THHN/THWN INSULATION RATED 600 VOLTS. MINIMUM WIRE SIZE SHALL BE #12 AWG. CONDUCTORS SHALL BE SOLID FOR WIRE SIZED #10 AWG AND SMALLER AND STRANDED FOR WIRE SIZES #8 AWG AND LARGER.
- METAL CLAD CABLE SHALL BE 90°C RATED CODE TYPE ACTHH WITH A SEPARATE GREEN B) INSULATED GROUND CONDUCTOR IN ACCORDANCE WITH UL 4. JACKET SHALL BE GALVANIZED STEEL ARMOR.
- C) CONDUCTORS SHALL BE COLOR CODED AS FOLLOWS:

208/120V	PHASE
BLACK	A
RED	В
BLUE	С
WHITE	NEUTRAL
GREEN	GROUND

- CONDUCTOR SIZES SHALL BE INCREASED WHERE REQUIRED BY CODE AND/OR THE D) ENGINEER TO COMPENSATE FOR VOLTAGE DROP AND HIGH AMBIENT TEMPERATURE.
- E) SPLICES FOR WIRE SIZES #8 AWG AND SMALLER SHALL BE MADE WITH WIRE NUTS AND TAPE. SPLICES FOR WIRE SIZES #6 AWG AND LARGER SHALL BE HYDRAULIC COMPRESSION TYPE WITH PRE-MOLDED COVER AND TAPE. ALL SPLICES SHALL BE WITHIN OUTLET OR JUNCTION BOXES. NO SPLICES TO FEEDERS SHALL BE PERMITTED.

1.07 WIRING DEVICES

WIRING DEVICES SHALL BE GROUNDING TYPE 15 OR 20 AMPERE, 125V VOLTS - COLOR AS SELECTED BY ARCHITECT. PROVIDE TAMPER RESISTANT AND GFI TYPE DEVICES WHERE

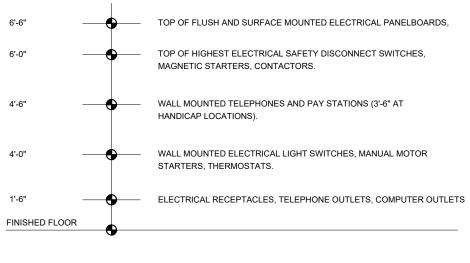

TYPICAL STANDARD DEVICE MOUNTING HEIGHTS DETAIL

- NOT TO SCALE
- NOTES: 1. MOUNTING HEIGHTS TO CENTER OF OUTLETS UNLESS OTHERWISE NOTED. IN MASONRY WALL CONSTRUCTION THE ABOVE MOUNTING HEIGHTS SHALL BE USED FOR REFERENCE TO NEAREST BLOCK OR BRICK COURSING.
 - 2. THE ABOVE MOUNTING HEIGHTS SHALL BE ADHERED TO UNLESS SPECIFICALLY NOTED OR DETAILED OTHERWISE ON THE DRAWINGS OR SPECIFICATIONS.

REQUIRED BY CODE

- B) FACEPLATES SHALL BE PLASTIC.
- C) LOCAL SWITCHES SHALL BE 20 AMPERE, 120 VOLT FLUSH TUMBLER QUIET OPERATION SINGLE, THREE WAY AND FOUR WAY AS REQUIRED.
- 1.08 BRANCH CIRCUIT PANELBOARDS
- A) BRANCH CIRCUIT PANELBOARDS SHALL BE 208/120V, 3Ø, 4-WIRE CONFIGURATION WITH COPPER BUS BARS, NEUTRAL BUS AND SEPARATE GROUND BUS BONDED TO PANEL ENCLOSURE. FEED-THROUGH LUGS & CABLE CONNECTIONS SHALL BE PROVIDE FOR MULTI SECTION PANELS. PANELBOARDS SHALL BE MANUFACTURED BY SCHNEIDER ELECTRIC/SQUARE D, GENERAL ELECTRIC, SIEMENS, OR CUTLER-HAMMER.
- CIRCUIT BREAKERS SHALL BE MOLDED CASE, PLUG-IN WITH THERMAL-MAGNETIC TRIP B) ELEMENT. MINIMUM INTERRUPTING RATINGS SHALL BE 10,000 AIC. CIRCUIT BREAKERS USED FOR HVAC EQUIPMENT SHALL BE "HACR" RATED. ALL CIRCUIT BREAKERS IN DWELLING UNITS SERVING LIGHTING AND POWER CIRCUITS SHALL BE AFCI TYPE. MULTIPOLE CIRCUIT BREAKERS SHALL HAVE SINGLE OPERATING HANDLE.
- C) PANELBOARD ENCLOSURES SHALL BE GALVANIZED CODE GAUGE STEEL. TRIMS SHALL BE SURFACE TYPE IN UNFINISHED SPACES AND FLUSH TYPE IN FINISHED SPACES, WITH ANSI 61 GRAY ENAMEL FINISH. DOORS SHALL BE DOOR IN DOOR TYPE CONSTRUCTION AND SHALL BE LOCKABLE AND ALL LOCKS SHALL BE KEYED ALIKE. FURNISH ONE KEY FOR EACH PANEL.
- D) FURNISH AND INSTALL TYPEWRITTEN DIRECTORIES FOR EACH PANELBOARD, NEW AND EXISTING, INDICATING DEVICES SERVED.

1.09 METER CENTERS

- A) ENCLOSURES SHALL BE CONSTRUCTED OF FORMED & WELDED CODE GAUGE GALVANIZED STEEL, NEMA 3R W/GRAY BAKED ENAMEL FINISH.
- B) ALL DEVICES MUST BE BONDED TOGETHER WITH BOLTED CONNECTIONS.
- C) COORDINATE METER TYPE WITH UTILITY COMPANY.
- D) ALL COMPONENTS SHALL BE FACTORY ASSEMBLED AND ALL CURRENT CARRYING PARTS SHALL BE PLATED BUSBARS.

1.10 SAFETY SWITCHES

A) SAFETY DISCONNECT SWITCHES SHALL BE 250V OR 600V AS REQUIRED, HORSEPOWER RATED, QUICK MAKE-QUICK BREAK DESIGN. SWITCH HOUSINGS SHALL INCLUDE COVER INTERLOCK AND LINE SIDE TERMINAL SHIELD AND GROUNDING LUG. FUSE CLIPS SHALL BE REJECTION TYPE. INTERRUPTING RATINGS SHALL BE A MINIMUM OF 100,000 AIC WHEN FUSED AND 12 TIMES THE CONTINUOUS CURRENT RATING WHEN UNFUSED AT RATED VOLTAGE.


1.11 GROUNDING

- A) THE DISTRIBUTION SYSTEM SHALL BE COMPLETELY AND PROPERLY GROUNDED USING APPROVED FITTINGS. SEPARATE INSULATED GROUND CONDUCTORS SHALL BE RUN WITH ALL FEEDERS, RECEPTACLE BRANCH CIRCUITS AND FLEXIBLE CONNECTIONS TO LIGHTING FIXTURES AND EQUIPMENT.
- B) METAL RACEWAYS, METAL ENCLOSURES OF ELECTRICAL DEVICES AND OTHER EQUIPMENT SHALL BE COMPLETELY GROUNDED IN AN APPROVED MANNER. PROPER HARDWARE REQUIRED FOR A COMPLETE GROUNDING SYSTEM SHALL BE INSTALLED BY THE CONTRACTOR.
- C) GROUND RODS SHALL BE $\frac{3}{4}$ X 10'-0" COPPERWELD TYPE WITH EXOTHERMICALLY WELDED CONNECTIONS.
- 1.12 CUTTING AND PATCHING
- A) ALL CUTTING AND PATCHING REQUIRED FOR EQUIPMENT INCLUDED IN THESE SPECIFICATIONS SHALL BE DONE BY THIS CONTRACTOR.
- B) THIS CONTRACTOR SHALL NOT DO ANY CUTTING THAT MAY IMPAIR THE STRENGTH OF BUILDING CONSTRUCTION. NO HOLES ARE TO BE DRILLED INTO ANY STRUCTURAL
- 1.13 SEALING OF PENETRATIONS
- A) ALL PENETRATIONS OF WALLS, FLOORS OR CEILINGS MUST BE SEALED IN AN APPROVED MANNER USING AN OUTER CIRCUMFERENTIAL SLEEVE FILLED INSIDE AND OUT.
- B) ALL PENETRATIONS OF FIRE RATED WALLS, FLOORS OR CEILINGS SHALL BE SEALED WITH APPROVED MATERIAL TO PROVIDE SAME RATING AS FLOOR, WALL OR CEILING ASSEMBLY. REFER TO ARCHITECTURAL DRAWINGS FOR LOCATIONS OF FIRE RATED PARTITIONS.

1.14 HANGERS AND SUPPORTS

- A) THREADED RODS SHALL BE FULLY GALVANIZED, MINIMUM 3/8" DIAMETER. MODULAR CHANNEL SUPPORTS SHALL BE GALVANIZED STEEL. SUPPORT CLIPS AND FASTENERS SHALL BE LISTED AND APPROVED FOR THE APPLICATION. STRAPS AND CLAMPS SHALL BE MALLEABLE IRON.
- SUPPORTS SHALL BE SIZED TO ACCOMMODATE THE LOAD REQUIRED. ALL WORK SHALL BE SUPPORTED INDEPENDENTLY OF THE WORK OF OTHER TRADES, INCLUDING CEILING SYSTEM SUPPORTS.

	ELECTRICAL SYMBOL LIST		
	LIGHTING		SERVICE EQUIPMENT
ОЮ	LED LIGHT FIXTURE - TYPES AS NOTED	J	JUNCTION BOX CF - INDICATES CEILING FAN
4	EMERGENCY BATTERY UNIT	\sim	MOTOR OUTLET - FINAL CONNECTION BY ELECTRIC CONTRACTOR
	LED LIGHT FIXTURE - TYPES AS NOTED	r	DISCONNECT SWITCH - UNFUSED - SIZE AS NOTED
'X' 🕅 H	EXIT LIGHT FIXTURE - TYPES AS NOTED	۳	DISCONNECT SWITCH - FUSED - SIZE AS NOTED
	SWITCHES	\frown	WIRING/CONDUIT - EXPOSED ABOVE CEILING OR CONCEALED IN PARTITION
s s ₃ s ₄	FLUSH TOGGLE SWITCH - 1 POLE, 3 WAY, 4 WAY	~~~~	WIRING/CONDUIT - IN OR BELOW SLAB OR UNDERGROUND
s _M	MANUAL MOTOR SWITCH WITH THERMAL OVERLOAD PROTECTION		NEW PANELBOARD
s _d	DIMMER SWITCH - SIZE AS REQUIRED LOW VOLTAGE SWITCH FOR VACANCY SENSOR CONTROL	TV	TV OUTLET - PROVIDE COAX TO CABLE SERVICE ENTRANCE.
a b	INDICATES SWITCH CONTROL		
OS	AUTO-ON / AUTO OFF, DUAL TECHNOLOGY OCCUPANCY SENSOR		COMMUNICATION SYSTEMS
	RECEPTACLES		TELEPHONE OUTLET PROVIDE 4/C TELEPHONE CABLE
€	DUPLEX RECEPTACLE		TO BASEMENT @ TELEPHONE SERVICE ENTRANCE.
\bullet	DUPLEX RECEPTACLE - GROUND FAULT INTERRUPTER		
\oplus	QUADRAPLEX RECEPTACLE		
⊜	DUPLEX RECEPTACLE ABOVE CEILING UNLESS OTHERWISE NOTED		
\oplus	SINGLE RECEPTACLE		
	DUPLEX RECEPTACLE- HALF SWITCHED/HALF CONNECTION		
н	SPECIAL RECEPTACLE TYPE AS REQUIRED FOR FIXTURE		
*	INDICATES DEVICE TO BE MOUNTED ABOVE COUNTER		

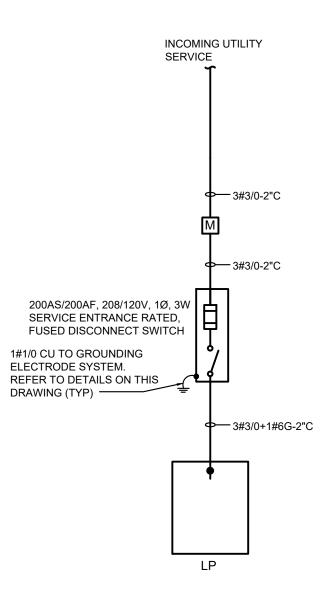

1 SINGLE LINE DIAGRAM E000 / SCALE: NTS

1. ALL WORK ASSOCIATED WITH ELECTRICAL SERVICE (INSIDE AND OUTSIDE) SHALL BE COORDINATED WITH UTILITY CO. PRIOR TO ANY INSTALLATION.


2. PRIOR TO ANY ELECTRICAL OR CONDUIT INSTALLATION, CONTRACTOR WILL VERIFY SERVICE REQUIREMENTS WITH THE UTILITY CO.

3. RECONNECT ALL EXISTING CIRCUITS INTO NEW PANEL.

	PANEL:	F	PANEL LP		208 / 120	VOLTS.	1 PHASE	3 WI	Æ	MAIN BU	JS 200	AMPS		
10			ASEMENT			Mounting:	SURFAC			MAINBE		AMPS	P	
	JILDING:		EKALB STREET		-	BUS	COPPER		1INUM	NEUTRA			 0,000	
	D FROM:		GLE LINE DIA GRA	Μ	-	ROUND BUS			-FEED LUGS			UGS ONLY	,	•
	ER SIZE:	SEE SING	LE LINE DIA GRA	M	-	.GND. BUS		* SHUNT TF		FEED:	TOP	ВТМ		
CKT	TRIP	DEOODI		D	LOAD		ASE (VA)	LOAD		FOODIDTI			TRIP	CKT
NO	AMPS	DESCRI	PTION OF LOA	D	(VA)	A	В	(VA)	D	ESCRIPTI	ON OF LOAI	J	AMPS	NO
1	15/1	EXIS	STING LOAD		720	4220		3500		EXI	HVAC		40/2	2
3	20/1	EXIS	STING LOAD		720		4220	3500						4
5	20/1	BAT	HROOM GFI		360	1360		1000		EXISTIN	NG LOAD		15/1	6
7	20/1	EXIS	STING LOAD		720		1720	1000		EXISTIN	NG LOAD		15/1	8
9	20/1	EXIS	STING LOAD		720	1440		720		EXISTIN	NG LOAD		15/1	10
11	20/1	SU	JMP PUMP		750		1470	720		EXISTIN	NG LOAD		15/1	12
13	20/1	EXIS	STING LOAD		720	1440		720		EXISTIN	NG LOAD		15/1	14
15	20/1	FIRE A	ALARM PANEL		500		1220	720		EXISTIN	NG LOAD		15/1	16
17			SPACE		0	720		720		EXISTIN	NG LOAD		15/1	18
19			SPACE		0		300	300		OUTSIE	DE LIGHT		15/1	20
21			SPACE		0	0		0		SP	ARE		15/1	22
23			SPACE		0		720	720		EXISTIN	NG LOAD		15/1	24
25			SPACE		0	720		720		EXISTIN	NG LOAD		20/1	26
27			SPACE		0		720	720		EXISTIN	NG LOAD		20/1	28
29			SPACE		0	180		180		RECEPT -	BASEMENT		20/1	30
		1	MULT FACTOR								SPA	RE FACTO	2	
TOTAL		2300	1.00	2300	TOTAL BY	10080	10370			DEMA ND	20450	Х	1.2	
TOTAL		1250	1.00	1250	PHASE				TOTA	L LOAD	25563	VA	123	AMPS
TOTAL TOTAL		9900	_ Per NEC 	9900	-									
TOTAL		0	1.00	000	_									
		v	_	0	_									

NOTES:

 $\langle 5 \rangle$ GROUNDING ELECTRODE (BUILDING STEEL/REBAR)

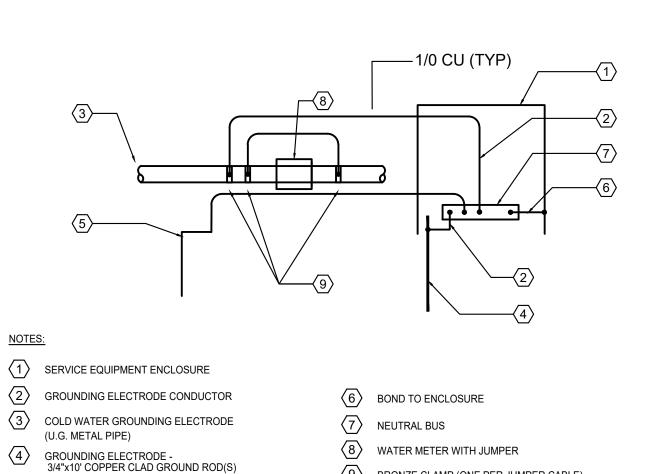



(9) BRONZE CLAMP (ONE PER JUMPER CABLE)

GROUNDING ELECTRODE SYSTEM E000/ SCALE: NTS

Clients: Integrated Design Solution Group, LLC ENGINEERS OF MECHANICAL, PLUMBING & ELECTRICAL SYSTEMS. 444 E. TOWNSHIP LINE RD. PO BOX 1467 HAVERTOWN, PA 19083 484-450-6054 integrateddesignsolution.llc@gmail.com ANDREW J. SILVESTRE, PE PA PROFESSIONAL ENGINEER NO. PE084363 Revisions: Project: INTERIOR **RENOVATION** 910 DEKALB ST NORRISTOWN, PA 19401 Drawing Title: ELECTRICAL COVER SHEE Date: Project No.: Drawn By: Checked By: Drawing Number: E0



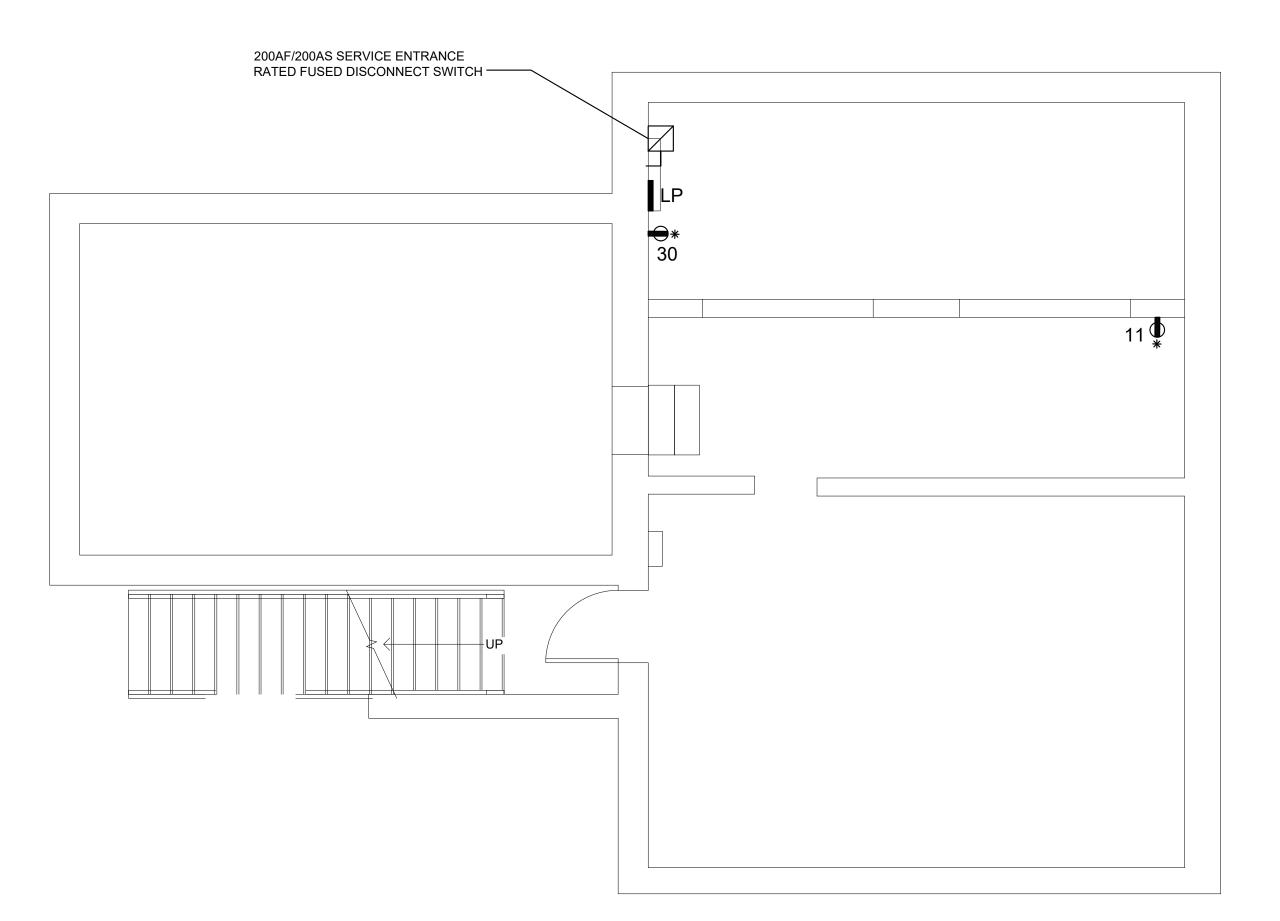

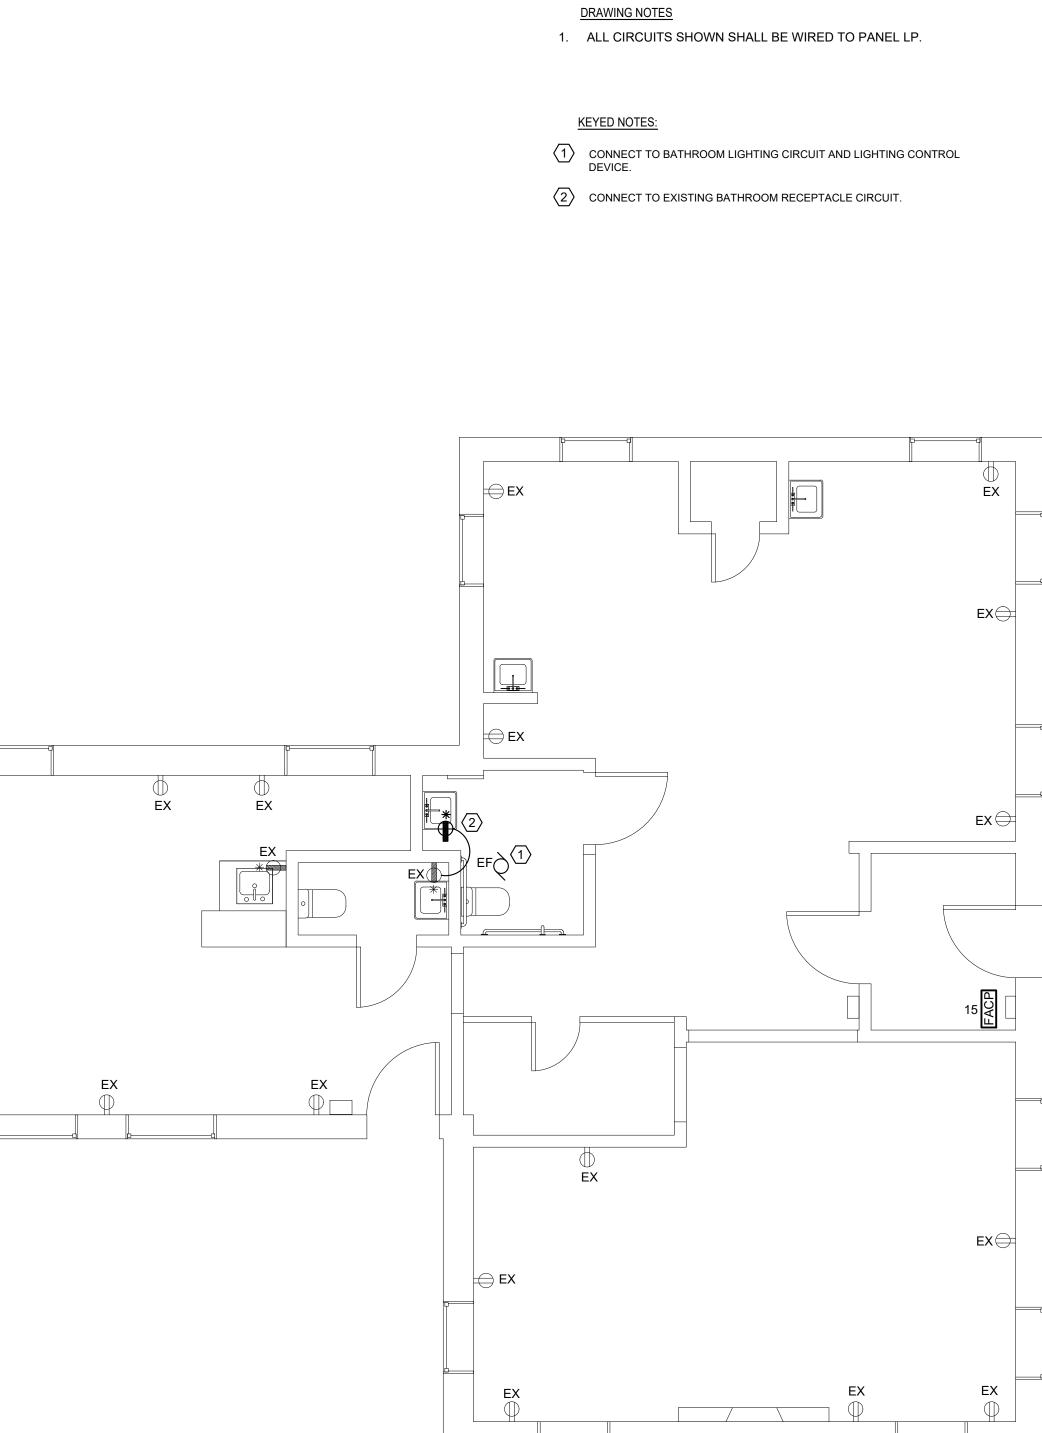

(|)


ΕX

⊖EX

Ex

2 FIRST FLOOR - POWER E1.0 SCALE: 1/4" =1'-0"

Clients:
Integrated Design Solution Group, LLC
ENGINEERS OF MECHANICAL, PLUMBING
& ELECTRICAL SYSTEMS.
444 E. TOWNSHIP LINE RD. PO BOX 1467
HAVERTOWN, PA 19083 484-450-6054 integrateddesignsolution.llc@gmail.com
integratedaesignsolonon.iic@gritali.com
~~~~~~~~~~~~~~~~~~~~~~~~~~~~~~~~~~~~~~~
WONWEAL A
PROFESSIONAL
ANDREW U. SNIVESSREND
PEOBA363
ANSY IV AND DO
ANDREW J. SILVESTRE, PE
PA PROFESSIONAL ENGINEER NO. PE084363
Revisions:
Project: INTERIOR
RENOVATION
910 DEKALB ST NORRISTOWN, PA 19401
ELECTRICAL
POWER PLANS
Date:
Project No.:
Drawn By:
Checked By:
Drawing Number:
E1.0

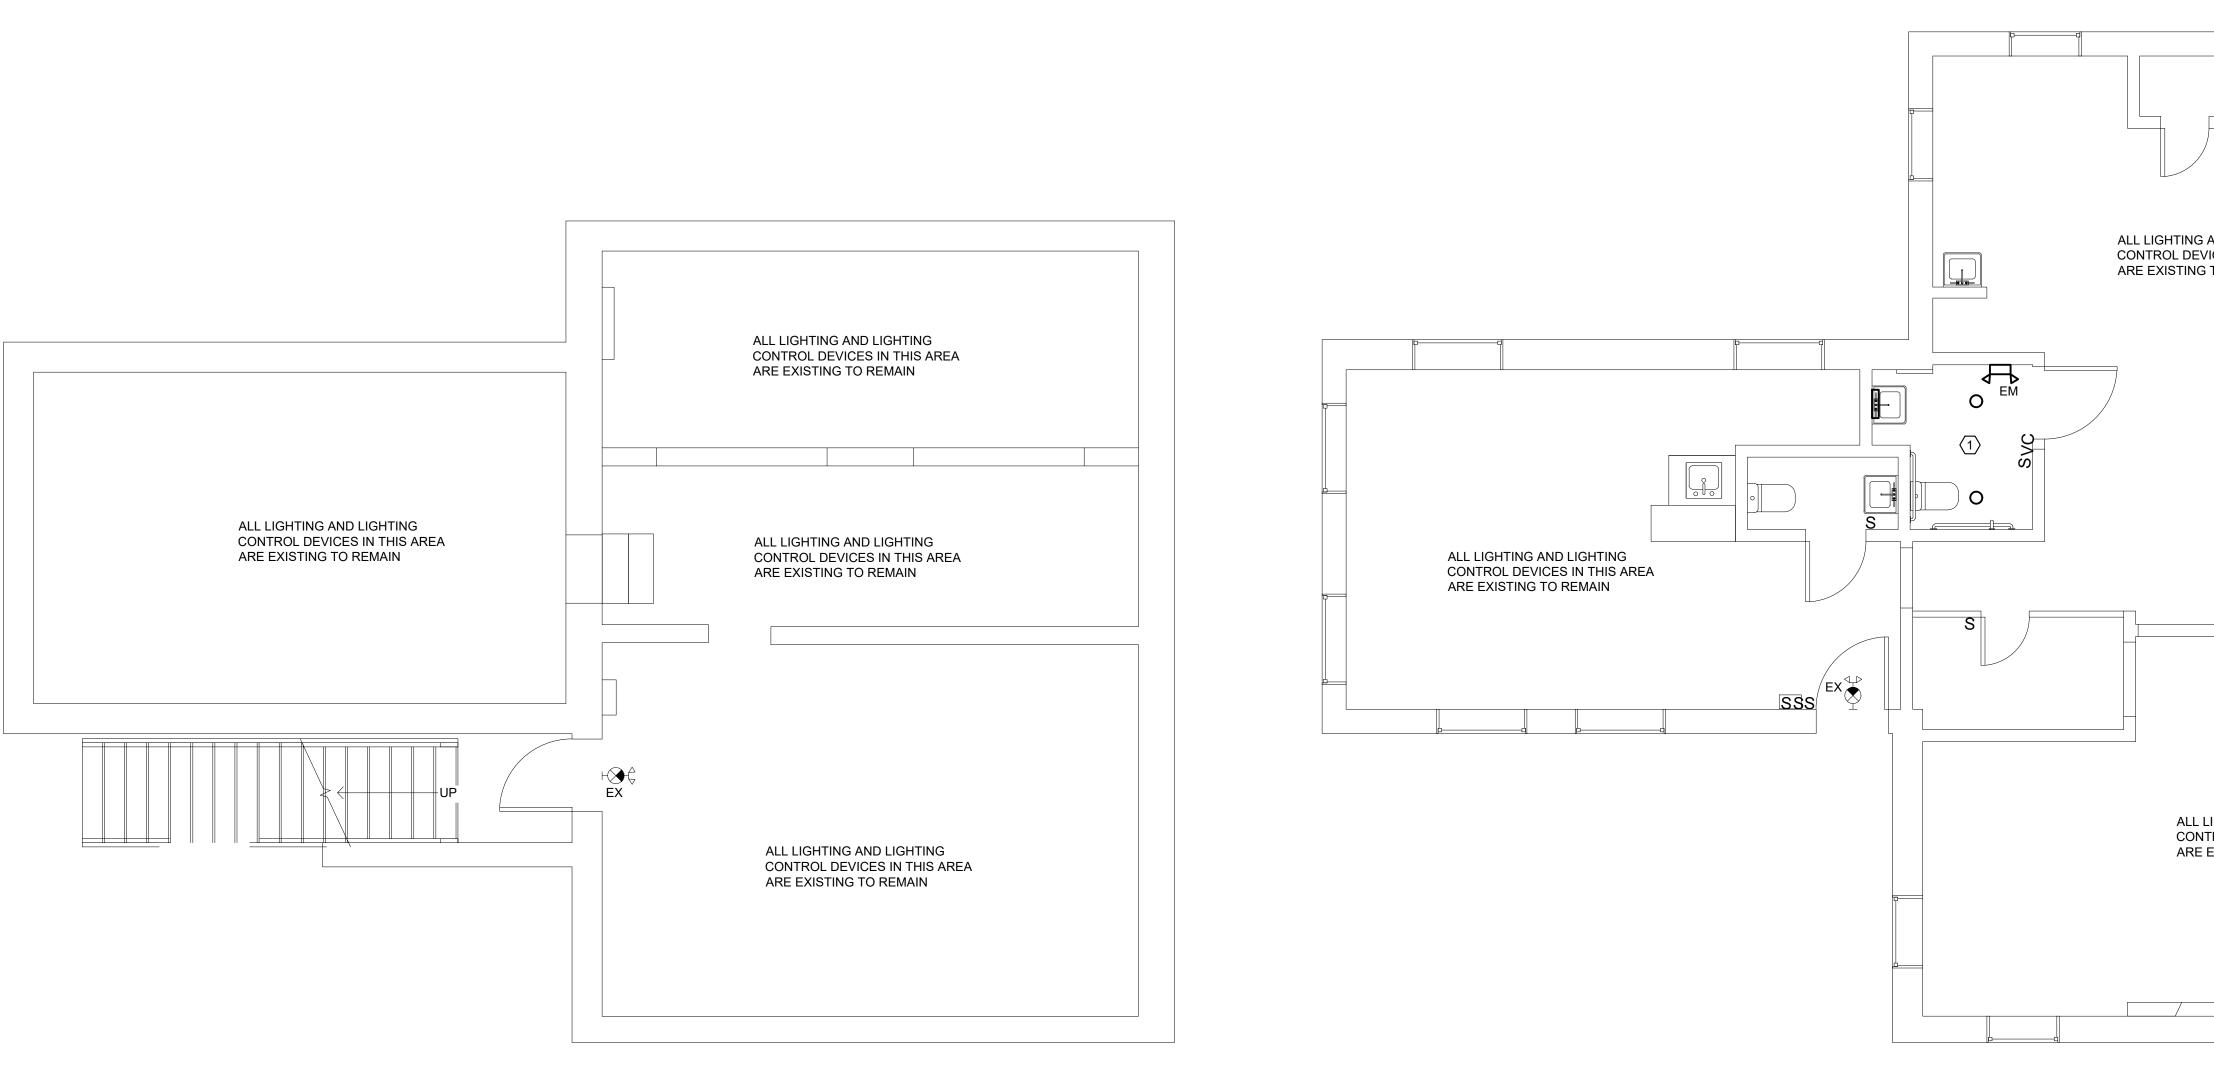

1 BASEMENT - LIGHTING E2.0 SCALE: 1/4" = 1'-0"

AREA. REFER TO ARCHITECTURAL PLANS FOR LIGHTING FIXTURE TYPES AND SPECIFICATIONS. ALL FIXTURES SHALL BE PROVIDED WITH LED LAMPS.

KEYED NOTES:



AND LIGHTING ICES IN THIS AREA TO REMAIN	
LIGHTING AND LIGHTING TROL DEVICES IN THIS AREA EXISTING TO REMAIN	

(1) CONNECT TO EXISTING LIGHTING CIRCUIT SERVING THE AREA.



& ELECTRICAL SYSTEMS. 444 E. TOWNSHIP LINE RD. PO BOX 1467 HAVERTOWN, PA 19083 484-450-6054 integrateddesignsolution.llc@gmail.com ANDREW J. SILVESTRE, PE PA PROFESSIONAL ENGINEER NO. PE084363

Clients:







ENGINEERS OF MECHANICAL, PLUMBING



Date: 

Revisions:

Project:

Drawing Title:

RENOVATION

910 DEKALB ST NORRISTOWN, PA 19401

ELECTRICAL LIGHTING PLANS


Project No.:


Drawn By:

Checked By:

Drawing Number:

E2.0

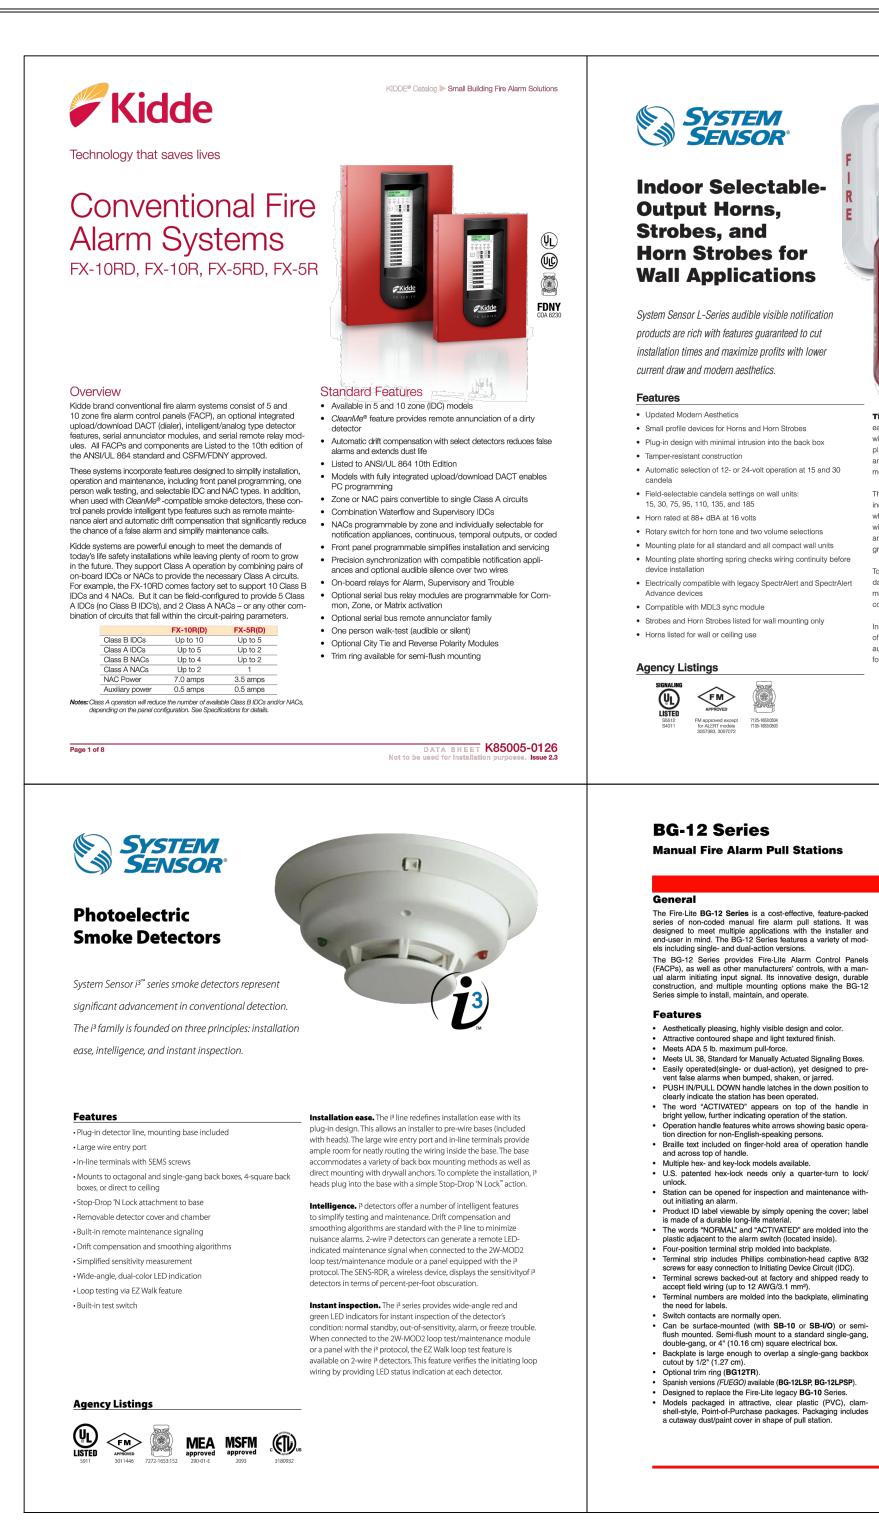


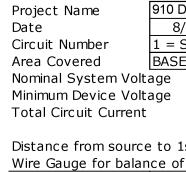

Enter curren	it in amps	Dist
.150 = 1	50 ma	fr
Device	Device	pre
Number	Current	de
Device 1	0.094	
Device 2	0.056	
Device 3	0.056	
Device 4	0.094	
Device 5	0.094	
Totals	1.898	1



	FIRE ALARM SYMBOL LIST
(S _D )	SMOKE DETECTOR SB - INDICATES WITH SOUNDER BASE CO - INDICATES WITH CARBON MONOXIDE DETECTION
C _o	CO DETECTOR - WITH SOUNDER BASE
F	FIRE ALARM SYSTEM PULL STATION WITH PROTECTIVE COVER
F	FIRE ALARM SYSTEM - VISUAL DEVICE
ÐÐ	FIRE ALARM SYSTEM - COMBINATION AUDIBLE/VISUAL DEVICE
$\Theta$	FIRE ALARM SYSTEM - AUDIBLE DEVICE

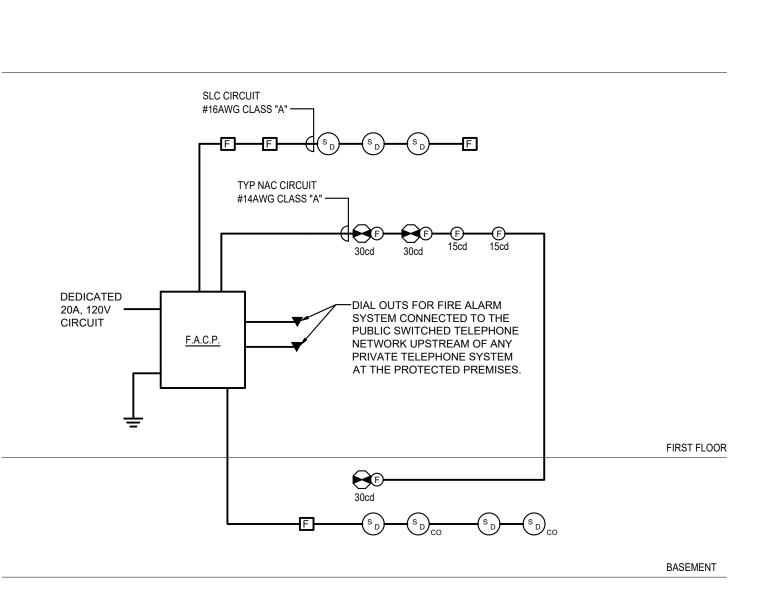



- LIMITED TO THE FOLLOWING:
- INDICATED. MOUNT SEMI-FLUSH AT 80" AFF, U.O.N.
- 5. ALL BOXES AND CONDUITS SHALL BE FIELD PAINTED RED.
- 6. ALL WIRING SHALL BE CLASS "A" UON.

- PROTECTION.
- 14. WIRING SHALL BE NUMBERED, MARKED, OR COLOR CODED.
- ORIGIN, AS SPECIFIED.
- - WIRING).

ITEM	DESCRIPTION	STANDBY		QTY		TOTAL	ALARM		QTY		TOTAL
		CURRENT		<b>L</b>		STANDBY	CURRENT		<b>_</b>		ALARM
		PER UNIT				CURRENT	PER UNIT				CURRENT
		(AMPS)				PERITEM	(AMPS)				PER ITEM
ACP	Fire Alarm Control Panel	0.1000	Χ	1	=	0.1000	0.2000	Х	1	=	0.2000
ANN	Annunciator	0.0000	Χ	0	=	0.0000	0.0480	Х	0	=	0.0000
SMOKE	Smoke Detector	0.0065	X	7	=	0.0455	0.0065	Χ	7	=	0.0455
HEAT	Heat Detector	0.0065	Χ	0	=	0.0000	0.0065	Χ	0	=	0.0000
PULL	Pull Station	0.0000	Χ	4	=	0.0000	0.0000	Χ	4	=	0.0000
BELL	FDC Bell	0.0000	Х	0	=	0.0000	0.0000	Χ	0	=	0.0000
MINI HORN	Horn	0.0000	X	0	=	0.0000	0.0290	Χ	0	=	0.0000
STROBE	Strobe	0.0000	X	2	=	0.0000	0.0560	Χ	2	=	0.1120
H/S	Horn/Strobe	0.0000	Х	3	=	0.0000	0.0940	Х	3	=	0.2820
				TOTAL SYS	TEM				TOTAL SYS	TEM	
		STAI	NDB	Y CURRENT (AM	IPS)	0.1455	ALARM		JRRENT (AM	PS)	0.6395
		REQUIRED		TOTAL		REQUIRED	REQUIRED		TOTAL		REQUIRED
		STANDBY		SYSTEM		STANDBY	ALARM TIME		SYSTEM		ALARM
		TIME (HRS)		STANDBY		CAPACITY	(HOURS)		ALARM		CAPACITY
				CURRENT		(AMP-HOURS)			CURRENT		(AMP-HOURS)
				(AMPS)					(AMPS)		
		24	Х	0.1455	=	3.4920	0.25	Χ	0.6395	=	0.1599
						•					
		REQUIRED		REQUIRED		TOTAL	TOTAL		SAFETY		ADJUSTED
		STANDBY		ALARM		CAPACITY	CAPACITY		FACTOR		BATTERY
		CAPACITY		CAPACITY		(AMP-HOURS)	(AMP-HOURS)				CAPACITY
		(AMP-HOURS)		(AMP-HOURS)							(AMP-HOURS)
		3.49	+	0.1599		3.6519	3.6519	+	20%	=	4
		•		·			· ·				

ITEM	DESCRIPTION	STANDBY		QTY		TOTAL	ALARM		QTY		TOTAL
		CURRENT		<b>Z</b>		STANDBY	CURRENT				ALARM
		PER UNIT				CURRENT	PER UNIT				CURRENT
		(AMPS)				PERITEM	(AMPS)				PERITEM
FACP	Fire Alarm Control Panel	0.1000	X	1	=	0.1000	0.2000	Х	1	=	0.2000
ANN	Annunciator	0.0000		0	=	0.0000	0.0480	X	0	=	0.0000
SMOKE	Smoke Detector	0.0065		7	=	0.0455	0.0065	X	7	=	0.0455
HEAT	Heat Detector	0.0065	Χ	0	=	0.0000	0.0065	Χ	0	=	0.0000
PULL	Pull Station	0.0000	Χ	4	=	0.0000	0.0000	Χ	4	=	0.0000
BELL	FDC Bell	0.0000	Χ	0	=	0.0000	0.0000	Χ	0	=	0.0000
MINI HORN	Horn	0.0000	Χ	0	=	0.0000	0.0290	Χ	0	=	0.0000
STROBE	Strobe	0.0000	X	2	=	0.0000	0.0560	Х	2		0.1120
H/S	Horn/Strobe	0.0000	Χ	3	=	0.0000	0.0940	Х	3	=	0.2820
				TOTAL SYS	TEM				TOTAL SYS	TEM	
		STA	NDB	Y CURRENT (AM	IPS)	0.1455	ALARM		JRRENT (AM	IPS)	0.6395
		REQUIRED		TOTAL		REQUIRED	REQUIRED		TOTAL		REQUIRED
		STANDBY		SYSTEM		STANDBY	ALARM TIME		SYSTEM		ALARM
		TIME (HRS)		STANDBY		CAPACITY	(HOURS)		ALARM		CAPACITY
				CURRENT		(AMP-HOURS)			CURRENT		(AMP-HOURS)
				(AMPS)					(AMPS)		
		24	X	0.1455	=	3.4920	0.25	Χ	0.6395	=	0.1599
						I	I		1 1		
		REQUIRED		REQUIRED		TOTAL	TOTAL		SAFETY		ADJUSTED
		STANDBY		ALARM		CAPACITY	CAPACITY		FACTOR		BATTERY
		CAPACITY		CAPACITY		(AMP-HOURS)	(AMP-HOURS)				CAPACITY
		(AMP-HOURS)		(AMP-HOURS)							(AMP-HOURS)
		3.49	+	0.1599	=	3.6519	3.6519	+	20%	=	4

					CIRCUIT								
				Point	to Point M	lethod	End	of Line Me	ethod	Load Centering Method			
DEKALB	ST				IS WITHIN	LIMITS	CIRCUIT	IS WITHIN	ILIMITS	CIRCUIT	IS WITHIN	ILIMITS	
3/6/2020													
STROBES	S ON FLO	OOR PLAN	J	To	tals	Voltage	Tot	tals	Voltage	То	tals	Voltage	
EMENT 8	k FIRST	FLOOR		Current	Distance	Drop	Current	Distance	Drop	Current	Distance	Drop	
	20			1.898	110	1.17	1.898	110	1.282	1.898	110	0.641	
	16			End of Lin	e Voltage	18.83	nd of Lin	e Voltage	18.72	End of Lin	e Voltage	19.36	
1.898		Wire	Ohm's	Pero	cent Drop	5.86%	Perc	cent Drop	6.41%	Per	cent Drop	3.20%	
		Gauge	Per 1000	of Line ar	nd Load Ce	entering M	ethods us	se only th	e wire gu	age for th	ne first de	vice to so	
1st devid	20	14	3.07		9	Standard V	Wire Resis	tance in (	Ohms per	1000 feet			
of circuit		14	3.07			18=7.77	16=4.89 14=3.07 12=1.98 10=1.24						
stance	'		1		18-14 Aw	/g = Solid	Conducto	ors 1	12-10 Aw	q = Stran	ded Condu	uctors	
from		Voltage	2	Notes:		<u> </u>				<u> </u>			
evious	At		Percent	Wire resi	stance is o	doubled in	the calc	ulations fo	or two wir	es (Positi	ve and Ne	gative)	
evice	Device	source	Drop		age calcula					•		5 ,	
20	19.77	0.233	1.17%	-	ifactures l				•				
20	19.55	0.455	2.27%	1			•	-	2 (	•	5	-	
	19.33	0.669	3.35%	<b>_</b>									
20	19.12	0.877	4.39%	-									
				-									

30 18.83 1.171 5.86% 110 End of Line Volta **18.83** 

# FIRE ALARM RISER DIAGRAM

1. THE CONTRACTOR SHALL PROVIDE THE FIRE ALARM SYSTEM AS REQUIRED AND AS INDICATED IN PLANS AND SPECIFICATIONS. FIRE DETECTION SYSTEM SHALL BE IN ACCORDANCE WITH 2015 IBC, NFPA 70 AND 72, LATEST ADOPTED EDITION. ALL COMPONENTS SHALL BE UL LISTED FOR FIRE SERVICE USE AND SHALL BE COMPATIBLE. THE SCOPE OF WORK INCLUDES, BUT SHALL NOT BE

2. PROVIDE SMOKE DETECTORS WHERE INDICATED.

3. PROVIDE COMBINATION STROBE/HORNS AND STROBES FOR BUILDING FIRE ALARM SYSTEM (GENERAL EVACUATION) WHERE

4. PROVIDE MANUAL PULL STATIONS WHERE INDICATED. MOUNT SEMI-FLUSH AT 48" AFF, U.O.N.

7. DETECTOR LAYOUT IS CONCEPTUAL. CONTRACTOR SHALL PROVIDE DETAILED DESIGN TO MEET CRITERIA STATED FOR APPROVAL BY OWNER'S UNDERWRITER AND LOCAL JURISDICTIONAL AUTHORITIES.

8. DETECTOR LAYOUT SHALL BE COORDINATED WITH ARCHITECTURAL REFLECTED CEILING PLAN AND BUILDING CONDITIONS. SEE MECHANICAL AND ELECTRICAL DRAWINGS FOR ADDITIONAL INFORMATION. SEE TYPICAL MOUNTING DETAILS.

9. REFER TO PLANS FOR QUANTITIES AND LOCATIONS OF DEVICES.

10. ALL FIRE ALARM CABLE SHALL BE PLENUM RATED. PROVIDE 3/4"C FROM OUTLET TO ABOVE CEILING FOR NEW SIGNAL DEVICES. PROVIDE 3/4" CONDUIT IN ELECTRICAL, MECHANICAL & ALL EXPOSED AREAS.

11. THE CONTROL PANEL SHALL BE CONNECTED TO A 120VAC, 60HZ POWER SUPPLY PER ARTICLE 760 OF THE NATIONAL ELECTRICAL CODE. THE CIRCUIT BREAKER SHALL BE DEDICATED TO THE FIRE ALARM PANEL(S) ONLY.


12. 120VAC POWER SUPPLY AND 24VDC BATTERY SUPPLY SHALL BE DISCONNECTED PRIOR TO SERVICING THE SYSTEM

13. FIRE ALARM PANELS SHALL BE CONNECTED TO EARTH GROUND PER ARTICLE 760 OF THE NATIONAL ELECTRIC CODE. FAILURE TO MAKE THIS CONNECTION WILL RESULT IN THE LOSS OF GROUND FAULT SUPERVISION AND THE REDUCTION OF TRANSIENT

15. WHEN SHIELDED CABLE IN METAL RACEWAY IS UTILIZED, THE WIRING SHIELDS SHALL ONLY BE CONNECTED AT THE POINT OF

16. ALL WIRING SHALL BE APPROVED AND COMPATIBLE FOR USE WITH FIRE ALARM SYSTEMS WITH 150Ø CELSIUS INSULATION. RUN WIRING CONCEALED IN WALLS OR CEILINGS, RUN WIRING IN CONDUIT IN EXPOSED AREAS. A. PROVIDE MINIMUM #14 AWG COPPER, TEFLON CABLE, 600V, 150 CELSIUS, HOSPITAL STANDARD APPROVED (STROBE LIGHT B. PROVIDE MINIMUM #16 AWG COPPER, TWISTED SHIELDED, TEFLON CABLE, 600V, 150 CELSIUS, APPROVED, LOOP NOT TO EXCEED 2000 FEET (ALL OTHER FIRE ALARM DEVICES AND SPEAKER WIRING).

Client	
	ntegrated Design Solution Group, LLC
&	NGINEERS OF MECHANICAL, PLUMBING ELECTRICAL SYSTEMS.
P' H	44 E. TOWNSHIP LINE RD. O BOX 1467 AVERTOWN, PA 19083
	84-450-6054 htegrateddesignsolution.llc@gmail.com
	REGISTERED CON
	PROFESSIONAL
	ANDREW U. SNUVESCREVED
	PEOBA363
	- Commission
	ANDREW J. SILVESTRE, PE PA PROFESSIONAL ENGINEER NO. PE084363
Revisi	ions:
Proje IN	
	NOVATION
• • •	
	0 DEKALB ST DRRISTOWN, PA 19401
	ing Title:
F	FIRE ALARM
C	OVER SHEET
_	
Date	
Proje Draw	ct No.: /n By:
	cked By:
	ving Number:
_	
F	FA0.1

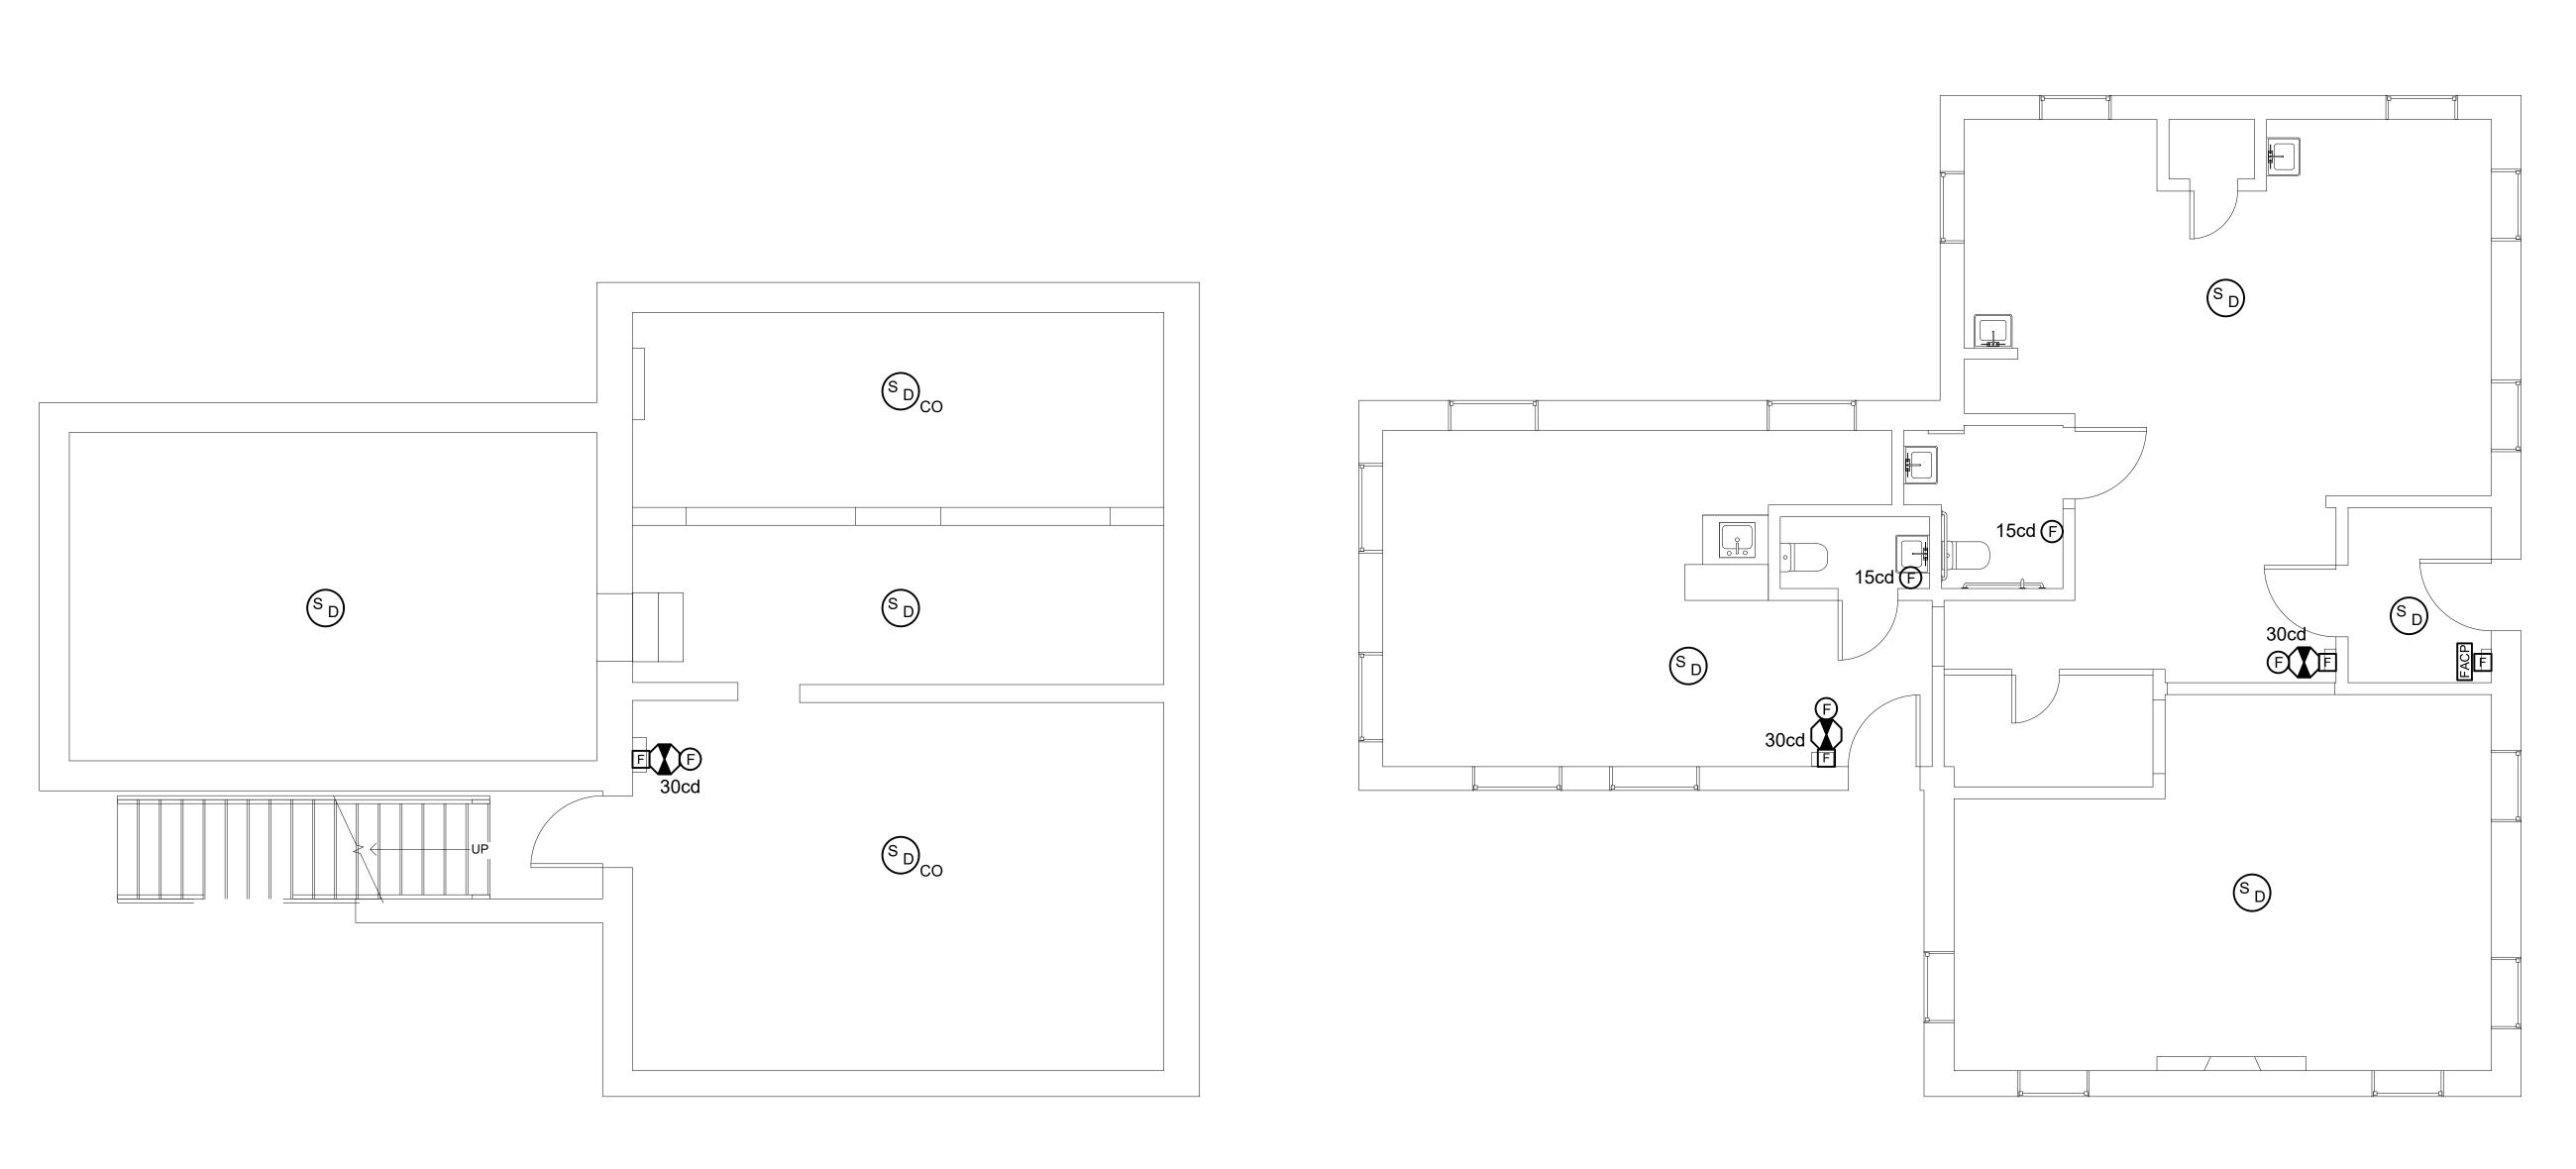

1 BASEMENT - FIRE ALARM FA100 SCALE: 1/4" =1'-0"

2 FIRST FLOOR - FIRE ALARM FA100 SCALE: 1/4" =1'-0"

Clients:
Integrated Design Solution Group, LLC
ENGINEERS OF MECHANICAL, PLUMBING & ELECTRICAL SYSTEMS.
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HAVERTOWN, PA 19083 484-450-6054 integrateddesignsolution.llc@gmail.com
integrateddesignsolotion.iic@gmdii.com
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ANDREW U. SNIVESERED
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ANDREW J. SILVESTRE, PE PA PROFESSIONAL ENGINEER NO. PE084363
I A I NOFESSIONAL ENGINEEK NU. PEU84303
Revisions:
Project:
INTERIOR
RENOVATION
910 DEKALB ST NORRISTOWN, PA 19401
Drawing Title:
FIRE ALARM
FLOOR PLANS
Date:
Project No.:
Drawn By: Checked By:
Drawing Number:
FA1.0



Municipality of Norristown Department of Building & Code Enforcement 235 E Airy Street, Norristown, PA 19401 Phone: (610) 270-0441 Fax (610) 279-7548



# **Plan Review Application**

2 sets of plans are required and will be returned to the Applicant. Please complete all applicable sections. Application Date: 09/04/2020 Applicant Name (Print): Lamar Hasben

Location of Propos	ed Work or Imp	roveme	nt:	910 I	) EKF	11bst	Norri	stown	$P_{A}.19401$
Parcel Number:			L	ot Number	:			hase:	
Subdivision/Land Development:							Section	:	
Describe Current Building Use: Offict									
Residential: R-1 R-2 R-3 (Single-Family & Two-Family Dwellings) R-4*									
	Commercial:	🗆 A-1	🗆 A-5	□ F-2	□ H-4	□ 1-3*	□ S-2		
		🗆 A-2	B	🗆 H-1	□ H-5	□ 1-4	οU		
Current Building		🗆 A-3	σE	🗆 H-2	□ I-1*	ΔM			
Use Group:		□ A-4	0 F-1	D H-3	□ I-2*	🗆 S-1			
	Building Uses v	with an (	*) mus	t have a con	dition id	entified.			
	Condition:	1 0 2	Π3	<b>04</b> 0!	5				

roperty Owner	Name: QORE DEVELON	TENT INC.	Date:	09/04/2020
Aailing Address:	6538 N. 16TH ST. PI	ila. PA. 19126		
Email: LHA	SDEN agmail. COM	Phone: (267)2	31-3904	Fax

Contractor Information

Contractor Name:

Date:

Contractor Name.					Date	·	
Mailing Address:							
Email:			Pho	ne:		pfiant	
		and type	e of Work or in	prove	nen en	non-cl	
Type of Work:	D New E	Building D Add	dition 🛛 🖄 Alteratio	n 🗆 Re	pair 🗆 Change d	ofUse	0 Other
Plans to be Reviewed	1: 🖄 Bu	ilding 🖄 Elect	rical & Plumbing	o Fire	Mechanical		ssibility
<b>Describe Proposed Work:</b> <b>Use extra sheets if needed</b> <b>Proposed one ADA companiant bathroom in existing vacant office.</b> <b>Legalized the existing office space, and legalized new fire alarm system</b>							

					Change i	n Use				and the second
Describe the Propo Use of the Buildin		No Chang	ged							
	Resid	dential: c	0 R-1	□ <b>R-2</b>	□ R-3 (Sing	gle-Family 8	Two-Fami	ly Dwellings)	□ R-4*	
	Com	mercial:	🗆 A-1	🗆 A-5	🗆 F-2	0 H-4	□ I-3*	🗆 S-2		
Drensed Building			🗆 A-2	ъB	🗆 H-1	🗆 H-5	□ I-4	οU		
Proposed Building			🗆 A-3	ΠE	□ H-2	□  -1*	пΜ			
Use Group:			□ A-4	🗆 F-1	□ H-3	□ I-2*	🗆 S-1			
	Build	Building Uses with an (*) must have a condition identified.								
	Cond	lition: 🗆	1 0 2	2 0 3	o 4 o	5				

If we have any questions regarding the submitted plans, or for pick-up of the plans and payment of the plan review fees who shall we contact?

© Property Owner © Contractor M Other: (*Please provide the contact person's name and contact information*) Contact Name: Hsing-Yuan Chen, AIA, LEED AP Phone: 646-236-0666

# APPROVAL OF ANY PLANS SUBMITTED FOR PLAN REVIEW IS NOT A PERMIT TO START WORK. PRIOR TO ANY WORK BEING CONDUCTED AT THE PROPERTY LOCATION THE APPLICANT MUST SUBMIT A PERMIT APPLICATION FOR APPROVAL AND PAY THE REQUIRED PERMIT FEES.

I understand that this application is for the purposes of plan review only. The information provided in this Application is true and correct to the best of my knowledge, information and belief and that these statements are made subject to the penalties of 18 Pa. C.S.A. Section 4904 relating to unsworn falsification to authorities. The undersigned is the owner of said structure or has been authorized by the owner(s) to act as agent in procuring the building permit herein requested. The undersigned also takes full responsibility for all work performed and will comply with all provisions of the Zoning Ordinance, the Building Code and with all applicable ordinances of Norristown.

# 

New Plan	n Reviewer Use Only	
Signature of Building Plan Reviewer:	Approved     Rejected	Fee: \$
Signature of Electrical Plan Reviewer:	Approved     Rejected	Fee: \$
Signature of Plumbing Plan Reviewer:	Approved     Rejected	Fee: \$
Signature of Mechanical Plan Reviewer:	Approved     Rejected	Fee: \$
Signature of Accessibility Plan Reviewer:	Approved     Rejected	Fee: \$
Signature of Fire Plan Reviewer:	Approved     Rejected	Fee: \$
Contact Called:	Total Fees Due: \$	



### Terms & Conditions

**Registration:** All persons interested in bidding on this property must complete a registration form, agree to the terms and conditions of the auction sale, and submit the required registration deposit.

**Deposit:** A \$5,000.00 deposit via wire transfer or cashier's check made payable to Wm. F. Comly & Son, Inc. is required in order to participate in the teleconference auction. The Auction Company must receive the deposit by 4:00 PM on Tuesday, May 11, 2021. Cashier's checks may be mailed to our office at 1825 E. Boston Street, Philadelphia, PA 19125. If you prefer to send the deposit via wire transfer, please contact the auction office at 215-634-2500 for wire instructions. The deposit is refundable unless you are the high bidder or the backup bidder.

Upon receipt of the completed registration form and the required deposit, Auction Company will provide you with a bidder number and the information needed to call into the teleconference auction on the day of the auction.

The Auction Company reserves the right to refuse registration or participation at any time at its sole discretion without notification.

**Property Preview:** Bidders may inspect the property and are urged to do so by appointment only, contact auction office to schedule. The property will be sold in "As Is" condition without warranty or representation of any nature whatsoever.

**Buyer's Premium:** A ten percent (10%) buyer's premium will be added to the final bid price.

**Finalizing the Agreement of Sale:** The purchase price is determined by adding the ten percent (10%) buyer's premium to the final bid on the property. At the conclusion of the teleconference auction, the highest bidder and the backup bidder shall be required to complete and sign the Agreement of Sale and submit it to the Auction Company no later than 4:00 PM on Friday, May 14, 2021 (the "Submission Deadline"). If either the highest bidder or the backup bidder fails to deliver their properly executed Agreement of Sale by the Submission Deadline, that bidder will be in default under these Auction Terms and Conditions and shall forfeit the \$5,000.00 registration deposit as liquidated damages.



Once the Agreement of Sale is signed by the Seller, the registration deposit of the highest bidder will automatically become the earnest money deposit payable under the Agreement of Sale. The successful purchaser shall make an additional deposit of ten percent (10%) of the final purchase price in certified funds within two (2) business days of the Agreement of Sale being signed by the Seller. Once the Auction Company receives that additional deposit, the registration deposit of the backup bidder will be returned.

However, if the highest bidder does not submit a properly executed Agreement of Sale to the Auction Company and/or does not send the additional ten percent (10%) deposit then the highest bidder shall forfeit the registration deposit as liquidated damages. In that event, the backup bidder will then become the purchaser and shall be required to make an additional deposit of ten percent (10%) of the final purchase price in certified funds within two (2) business days of that Agreement of Sale being signed by the Seller. If the additional deposit is not received by the Auction Company within the designated time frame, the backup bidder shall forfeit the \$5,000.00 registration deposit as liquidated damages.

If the Seller does not sign the Agreement of Sale, the deposit(s) will be returned to the appropriate bidder(s) and the Agreement of Sale will become null & void.

**Settlement:** The balance of the purchase price together with the net amount of any adjustments shall be paid by cashier's check at the time of settlement. Settlement will take place on or before Friday June 11, 2021.

**Title:** The successful purchaser will receive a deed for the property at the time of settlement.

**Conditions:** The property will be sold in "AS IS" condition without warranty or representation of any nature whatsoever. All statements oral or written made at or before the time of the auction including but not limited to the sale brochure, advertisement, or the bidder's information package, pertaining to but not limited to location, zoning, taxes, condition, title, survey, etc. of the property are for information only, and should be verified by the purchaser prior to making a bid and such bid shall not be in reliance upon any representations oral or written made by WM. F. COMLY & SON, INC. or its representatives. All announcements from the auction block will take precedence over any previously printed material or any other statements made.



### **Registration Form**

### Teleconference Auction Sale: Wednesday, May 12, 2021 910 DeKalb Street, Norristown, PA 19401

Date:

Company Name	
First Name	
Last Name	
MailingAddress	
City, State, Zip	
Telephone	
Fax Number	
Email Address	
Deposit- \$5,000.00 (Cashier's Check or Wire Transfer)	

I acknowledge that I have read, am familiar with, and agree to comply with the Terms & Conditions of the auction sale.

Signature _____

Date _____

Deposit Received _____

Bidder Number_____

This registration form may be faxed or emailed to Auction Office. Mail cashier's check deposit to our office at the address listed above. Contact Auction Office for wire instructions at (215) 634-2500.



### **BROKER PARTICIPATION REQUIREMENTS**

Comly Auctioneers & Appraisers will share its commission with any broker whose qualified buyer pays in full and settles on the property.

To qualify for a commission, the real estate agent must be a qualified and duly licensed broker, and must first register the buyer by sending in the buyer/broker registration form. Both you and your prospect must sign and date the form where indicated.

Comly Auctioneers & Appraisers must receive the buyer/broker registration form at or before any inspection of the property by the buyer and, in any event, at least forty-eight (48) hours prior to the auction. The broker must inspect the property with the buyer and sign in with the buyer during a scheduled property inspection.

A complete registration file on all brokers and buyers will be maintained.

No commission will be paid by the seller to any broker participating in the purchase of the property and an affidavit will be required that the broker is serving only as a broker and not as principal and is not related to or affiliated with the buyer in any way.

The auction company will pay a commission up to two (2%) percent of the final bid price. No commission will be paid to any broker unless all of these requirements are satisfied. There can be no exceptions to this procedure and no oral registrations will be accepted.

### **BUYER/BROKER REGISTRATION FORM**

(Must be completed IN FULL and forwarded to Auction Company within forty-eight (48) hours of the auction sale)

### **Auction Property Information**

### **Broker / Agent Information**

Broker / Agent's Name	Real Estate License #
Company	Address
City / State / Zip Code	Email
Telephone / Fax	
<b>Buyer Information (will remain confidential)</b>	
Name	Company (if applicable)
Address	City / State / Zip Code
Email	Phone / Fax

**Broker / Agent hereby agrees to the following:** If my buyer is the successful bidder at the auction and settles on the property, I will receive a commission of two percent (2%) of the opening bid submitted on this form and one percent (1%) of all amounts over the opening bid made by my buyer. If no opening bid is submitted the total commission due is one percent (1%) of the high bid.

**Broker / Agent** 

**Buyer hereby agrees to the following:** I shall not withdraw or rescind my opening bid prior to or following the start of the auction.

**Potential Buyer** 

Date

Date

\$

### **OPENING BID AMOUNT**

(Must be filled out for Broker / Agent to receive a 2% commission)

**Comly Auctioneers & Appraisers** 

Date

Comly Auctioneers & Appraisers – 1825 E. Boston Street, Philadelphia, PA 19125 Phone: (215) 634-2500 - Fax: (215) 634-0496 – Email: <u>auctions@comly.com</u>

### AGREEMENT OF SALE

This agreement of Sale of Real Estate dated	this 12 th day of May, 2021 between Qore
Development Inc. whose address is 6538 N 10	6 th Street, Philadelphia, PA 19126 ("Seller")
AND Buyer's Name:	("Buyer")
Buyer's Social Security No. or Tax ID No.:	
Buyer's address:	
Buyer's telephone number:	
Buyer's fax number:	_ Cell number:
Buyer's email address:	

The words Buyer and Seller jointly and severally include all buyers and sellers listed above.

- **1. SALE AND PURCHASE.** Seller hereby agrees to sell and convey to Buyer, who hereby agrees to purchase the property described in this Agreement.
- 2. PROPERTY. The property to be sold consists of (a) the land and all the improvements, and fixtures on the land, if any; and (b) all of Seller's rights and obligations relating to the land. Together, these are referred to as the "Property." The Property to be sold is located in the County of Montgomery, City of Norristown in the Commonwealth of Pennsylvania, also known as: 910 DeKalb Street. The Property is also identified as Tax Parcel Number: 13-00-09636-00-8.

### **3. PURCHASE PRICE.**

High Bid	\$
Plus a 10% Buyer's Premium	\$
Equals the Purchase Price of (the "Purchase Price").	\$

# **4. PAYMENT OF PURCHASE PRICE.** Buyer will pay the Purchase Price as follows:

Registration Deposit (wire transfer or bank check)	\$ 5,000.00
Additional Deposit of ten percent (10%) of the final purchase price within two (2) business days of acceptance of offer by Seller	\$ 
At settlement (wire transfer or bank check)	\$ 

The Deposit will be held by Wm. F. Comly & Son, Inc. ("Auction Company") in an escrow bank account until settlement. If settlement is completed in accordance with this Agreement, the Deposit will be credited to Buyer. If there is a dispute between Buyer and Seller over who is entitled to the Deposit, Auction Company will not be responsible to resolve that dispute and will not be liable to either Buyer or Seller for refusing to release the Deposit without an adequate written agreement between Buyer and Seller or a final order of a court of competent jurisdiction.

**5. CASH TRANSACTION.** The Buyer represents and warrants that Buyer presently has sufficient cash and assets to pay the Purchase Price in full. This Agreement is not contingent in any way upon Buyer obtaining a mortgage or any other type of financing to complete the purchase or selling any other property.

### 6. FIXTURES AND PERSONAL PROPERTY.

- a. INCLUDED in this sale and Purchase Price are all existing items.
- 7. TIME AND PLACE OF SETTLEMENT. The settlement will take place on or before Friday, June 11, 2021. Final settlement will be held at the local office of attorney or Title Company representing the Buyer unless otherwise agreed upon between Buyer and Seller. Such office shall be within five miles of the Property unless otherwise agreed upon between Buyer and Seller. Buyer will give Seller at least ten (10) days written notice of the date and place of settlement. The date of settlement is not extended by any other provisions of this Agreement and may only be extended by written agreement between Buyer and Seller.
- 8. DATES/TIME IS OF ESSENCE. Seller and Buyer agree that all times and dates for performance of this Agreement are of the essence. This means that Seller and Buyer must perform what is required of them within the time limits set by this Agreement.
- **9. TRANSFER OF OWNERSHIP.** At the settlement, Seller will transfer ownership of the Property to Buyer. Seller will give Buyer a properly executed deed (the "Deed"). A deed is a written document used to transfer ownership of property.
- **10. PREPARATION OF DOCUMENTS. CONVEYANCING EXPENSES.** The Deed will be prepared, acknowledged and delivered by Seller, and recorded by and at the expense of Buyer. The deed must be presented by Seller to Buyer for examination and approval at least ten (10) days prior to the date fixed for the settlement. All other settlement expenses including, without limitation, title searches, and title insurance, will be paid by Buyer. Buyer agrees to provide Seller with a copy of Buyer's title insurance commitment at least ten (10) days before the time fixed for the settlement.
- **11. TRANSFER TAXES/FEES.** Any and all real estate transfer taxes or fees imposed upon this sale will be divided and borne equally between Buyer and Seller.

- **12. ADJUSTMENTS AT SETTLEMENT.** At the time of settlement, the following will be adjusted pro-rata on a daily basis between Buyer and Seller reimbursing where applicable: all real estate taxes and assessments for the current year (in no event will Seller be charged with or responsible for any increase in the real estate taxes after settlement), if any; water and/or sewer fees, if any, together with any other lienable municipal service, if any, rents due from current tenants. The charges are to be pro-rated for the period(s) covered; Seller will pay up to and including the date of settlement; Buyer will pay for all days following settlement.
- **13. DEFAULT.** If Buyer fails to consummate the settlement as required by, and in compliance with the terms of this Agreement, Seller may either: (a) keep the Deposit as liquidated damages and not as a penalty (this means that Seller is conclusively presumed to have suffered damages in the amount of the Deposit and may keep the Deposit without proving those damages in court); or (b) apply the Deposit toward the Purchase Price and pursue any legal or equitable remedies available. In order to enforce the provisions of this Agreement against Buyer, Seller will not be required to formally offer (tender) to Buyer a deed to the Property if Buyer defaults in paying the balance of the Purchase Price. Buyer acknowledges that its waiver of any right it may have to prove that Seller has suffered actual damages in an amount less than the Deposit is a material inducement to Seller entering into this Agreement with Buyer.
- 14. INSPECTION BY SURVEYORS, ENGINEERS, APPRAISERS AND/OR INSPECTORS. Seller agrees to permit inspections upon reasonable advance notice, by authorized appraisers, reputable certifiers, insurer's representatives, surveyors, municipal officials and/or Buyer as may be required by Buyer's mortgage lender, if any, and insuring agencies. Seller further agrees to permit any other inspections required by or provided for in the terms of this Agreement. Buyer has the right to attend all inspections. Buyer reserves the right to make a pre-settlement walk-through inspection of the Property. Buyer's right to make this inspection is not waived by any other provision of this Agreement.
- **15. MORTGAGE FINANCING.** This sale is not conditional upon the Buyer obtaining mortgage financing. If Buyer does apply for a mortgage and the mortgage company requires inspections of the Property they must be done in a reasonable time and upon reasonable advance notice, and the cost of those inspections and repairs is the responsibility of the Buyer and not the Seller.
- **16. POSSESSION.** Possession is to be delivered by Deed and physical possession to Property.

### 17. CONDITION AND INSURABILITY OF TITLE AND COSTS.

a. The property is to be conveyed free and clear of all liens, encumbrances, and easements, excepting however the following: existing deed restrictions, historic preservation restrictions or ordinances, building restrictions, ordinances, easements of roads, easements visible upon the ground, easements of record, privileges or rights of public service companies, if any, land use restrictions pursuant to property enrollment in a preferential tax program, if any; otherwise the title to the Property will

be good and marketable and such as will be insured by a reputable Title Insurance Company at the regular rates.

- b. In the event Seller is unable to give good and marketable title and such as will be insured by a reputable Title Insurance Company at regular rates, as aforesaid, Buyer will have the option of taking such title as Seller can give without changing the Purchase Price or of being repaid all monies paid by Buyer to Seller on account of the Purchase Price in which event this Agreement will become void.
- c. Buyer will pay for the following:(1) Title search, title insurance and/or mechanics lien insurance or fee for cancellation of same, if any;

(2) Flood insurance, fire insurance with extended coverage, and cancellation fees, if any;

(3) Buyer's customary settlement costs and charges.

- d. If Seller is unable to transfer title as required by this Agreement, Seller shall have an additional ten (10) days from the date fixed for settlement to correct any defect in title. If at the end of the additional ten (10) days Seller is still unable to transfer title in accordance with this Agreement, Buyer may cancel this Agreement. If Buyer cancels this Agreement, Seller shall instruct Auction Company in writing to pay to Buyer the entire amount of the Deposit held by Auction Company, this Agreement shall become void, and Seller shall not be liable for any other claim. In lieu of cancelling this Agreement, Buyer may, however, accept such title as Seller can convey, without any reduction in the Purchase Price.
- **18. ZONING CLASSIFICATION.** The current zoning classification for the property is Commercial. Buyer agrees to purchase the Property in its present condition **"as is"**. Seller does not represent that the Property may be used for any particular purpose.
- **19. ASSESSMENTS FOR MUNICIPAL IMPROVEMENTS.** Certain municipal improvements such as sidewalks and sewers may result in the municipality charging the property owners to pay for the improvement. All assessed charges against the Property for work completed before the date of this Agreement will be paid by Seller at or before the settlement. Seller shall not be liable for any work done or ordered done after the date of execution of this Agreement by any municipality, agency, or other public authority, or for any notice issued after the date of execution of this Agreement which directs any action to be done or not to be done on, in, or to the Property by any municipality, agency, or other public authority, and Buyer agrees to take title subject to any lien that may be recorded as a result thereof.
- **20. STATUS OF WATER.** Seller represents that the Property is served by public water.
- **21. STATUS OF SEWER.** Seller represents that Property is served by public sewer.
- **22. INSPECTION OF THE PROPERTY.** BUYER ACKNOWLEDGES THAT BUYER HAS BEEN GIVEN THE OPPORTUNITY TO AND HAS ADEQUATELY INSPECTED THE PROPERTY AND/OR HAS WAIVED THE

OPPORTUNITY TO MAKE SUCH AN INSPECTION. BUYER FURTHER ACKNOWLEDGES THAT BUYER HAS ENTERED INTO THIS CONTRACT AS A RESULT OF THE INSPECTION MADE BY BUYER AND NOT AS A RESULT OF ANY ADVERTISEMENT, HANDBILL, OR ANY OTHER REPRESENTATION, OR WARRANTY, EITHER ORAL OR WRITTEN, EXPRESS OR IMPLIED, MADE BY SELLER, ANY OF ITS EMPLOYEES, REPRESENTATIVES, AGENTS, OR THE LIKE, ANY SELLING AGENT OR BY AUCTION COMPANY. BUYER FURTHER AGREES THAT NEITHER SELLER NOR AUCTION COMPANY SHALL BE RESPONSIBLE FOR ANY ERRORS IN ANY ADVERTISEMENT, HANDBILLS, OR ANNOUNCEMENT MADE neither BY SELLER OR AUCTION COMPANY NOR FOR ANY AGREEMENT, CONDITION, OR REPRESENTATION, INCLUDING BUT NOT LIMITED TO ANY REPRESENTATION REGARDING THE VALUE OF ANY REAL ESTATE, OR ANY STIPULATION, ORAL OR WRITTEN, NOT CONTAINED IN THIS CONTRACT. BUYER HAS MADE AN INDEPENDENT DETERMINATION OF THE VALUE OF THE PROPERTY AND HAS NOT RELIED ON ANY INFORMATION FROM SELLER OR SELLER'S AGENT(S) REGARDING THE PROPERTY'S VALUE.

- **23.** PHYSICAL CONDITION OF THE PROPERTY. The property is being sold "As Is, Where Is" and "with all faults and defects", and Buyer acknowledges that Seller and Auction Company have not made and Buyer has not relied upon any representation or warranty regarding the Property. Seller and Auction Company do not make any claims or promises whatsoever about the Property including, without limitation, the condition or value of the Property. Neither Seller nor Auction Company makes any representations as to the presence or absence of any hazardous or toxic substances on the Property. Buyer agrees to accept the Property (including any and all improvements located thereon) in "as is" condition, without any representations or warranties of the Seller or Auction Company.
- 24. FLOOD AREAS. The federal and state governments have designated certain areas as flood areas. If the Property is located in a flood area, the use of property may be limited. Seller makes no representation as to whether or not the Property, or any portion thereof, is in a flood area.
- **25. REAL ESTATE RECOVERY FUND.** A Real Estate Recovery Fund has been established by the Commonwealth of Pennsylvania to reimburse any person who has obtained a final civil judgment against a Pennsylvania real estate licensee as a result of fraud, misrepresentation, or deceit in a real estate transaction, if that person has been unable to collect the judgment after exhausting all legal and equitable remedies. For complete details about the Fund, call (717) 783-3658.
- **26. PERFORMANCE OF DUTIES.** Auction Company is performing its duties under the rules and regulations set forth in the Auctioneer and Auction Licensing Act of the Commonwealth of Pennsylvania. For information call (717) 783-3397.
- 27. CONDEMNATION/TAKING OF THE PROPERTY BY EMINENT DOMAIN. If all or a material part of the Property is taken between the date of this Agreement and the date of settlement by the exercise of the power of

condemnation/eminent domain by any local, state, or federal body, Buyer may either: (a) terminate this Agreement and receive a refund of the Deposit; or (b) complete settlement at the full Purchase Price, in which case Buyer shall be entitled to an assignment of all rights to the condemnation/eminent domain award or compensation.

- **28. RECORDING.** Buyer shall not record this Agreement or any memorandum of this Agreement in any state, county, or municipal recording office. Any recording or attempt at recording will be deemed a breach of this Agreement and be null and void.
- **29. ASSIGNMENT.** Buyer shall not assign this Agreement without the express prior written consent of Seller, which may not be unreasonably withheld by Seller. In the event that the Seller consents to Buyer assigning its rights under this Agreement, any such consent shall in no way release Buyer or any person or entity claiming by, through, or under Buyer from any of its obligations under this Agreement.
- **30. ADVERTISING OF AUCTION.** Buyer agrees that lot sizes, lot areas, lot plans, building descriptions, building locations, equipment & contents of the building shown or described in any Auction circular or other Auction advertisement of this sale may not be accurate. Buyer further agrees that Buyer is relying upon the description contained in or referred to in this Agreement, and upon his own inspection of the Property and not upon any other description or representation made by Seller or Seller's agents.
- **31. USE AND OCCUPANCY.** Buyer recognizes that prior to any use or occupancy of the Property Buyer will be responsible for obtaining any governmental permits, including but not limited to a municipal use and occupancy permit. Buyer's obligation to complete settlement is NOT contingent upon Buyer obtaining any such permits and Buyer specifically agrees that Buyer shall be obligated to complete settlement even if Buyer has not yet obtained all permits required to use or occupy the Property.
- **32. ESCROWEE.** It is understood and agreed that Auction Company shall not be held liable by either Seller or Buyer for the performance or nonperformance of any provision of this Agreement, except to account for any Deposit paid to it. Buyer and Seller shall indemnify and hold Auction Company harmless for any and all costs, claims, liability or damages of any kind resulting from this Agreement, including, but not limited to, reasonable attorney fees. The obligation of this paragraph shall survive settlement.
- **33. CERTIFICATION OF NON-FOREIGN INTEREST.** Seller is not a "foreign person" (as defined in Section 1445(f) of the United States Internal Revenue Code of 1954, as amended (the "Code") and Seller will, at the Closing, furnish an appropriate affidavit to such effect in order that no withholding of tax will be required pursuant to Section 1445 of the Code.
- **34. RISK OF LOSS.** Any loss or damage to the Property caused by fire, or other casualty commonly covered by extended endorsement by reputable insurance

companies, between the date of this Agreement and the settlement date shall not in any way void or impair any of the conditions and obligations hereof, and Buyer shall be required to accept the Property in its then damaged condition without abatement of the Purchase Price (except for the credit referenced below). It shall be the Buyer's responsibility at his own cost and expense to carry such insurance on the Property, from and after the date hereof, as he may deem advisable. The Seller shall continue to keep in effect all of its current insurance policies in connection with the Property (collectively, "Seller Policies") at their present insured value until the settlement date. Any amounts recovered by Seller under the Seller's Policies shall be assigned to the Buyer at settlement (this process will not affect the commission or buyer's premium). There shall be no other reduction in the Purchase Price by reason of such unpaid claim.

**35. NOTICES.** Except as otherwise provided, all notices to be given by either party to the other shall be in writing and delivered personally or sent by Certified Return Receipt First Class United States Mail, postage paid, by recognized overnight delivery service providing positive tracking of items (for example, Federal Express) to the address first written above.

### **36. MISCELLANEOUS.**

- a. All of the representations and warranties contained in this Agreement, all covenants, agreements, and indemnities made herein, and all obligations to be performed under the provisions hereof shall survive settlement.
- b. This Agreement may be executed in two or more counterparts, each of which shall be deemed an original, and all counterparts shall collectively constitute a single agreement.
- c. If any term, covenant, condition or provision of this Agreement or the application thereof to any person or circumstance shall be invalid or unenforceable, at any time or to any extent, the remainder of this Agreement, or the application of such term or provision to persons or circumstances other than those as to which it is held invalid or unenforceable, shall not be affected thereby, unless such invalidity or unenforceability materially frustrates the intent of the parties as set forth herein. Each term, covenant, condition and provision of this Agreement shall be valid and enforced to the fullest extent permitted by law.
- d. The captions in this Agreement are inserted for convenience of reference only and in no way define, describe, or limit the scope or intent of this Agreement or any of the provisions hereof.
- e. Formal tender of an executed deed is hereby waived.
- f. This Agreement shall be binding upon and shall inure to the benefit of the parties hereto and their respective heirs, executors, administrators, legal representatives, successors, and permitted assigns.
- g. This Agreement, including any exhibits and addendums attached hereto, contains the whole agreement as to the Property between Seller and Buyer, and there are no other terms, obligations, agreements, covenants, representations, statements, or conditions, oral or otherwise, of any kind whatsoever, concerning this sale and purchase. This Agreement shall not be altered, amended, changed or modified except in writing executed by the parties hereto.

- h. This Agreement shall be construed in accordance with the laws of Pennsylvania.
- i. Both parties to this Agreement have participated fully and equally in the negotiation and preparation hereof, and therefore, this Agreement shall not be more strictly construed, or any ambiguities within this Agreement resolved, against either party hereto.
- j. Attached to this Agreement is the Seller's Disclosure Statement.
- k. Attached to this Agreement is the Disclosure of Information on Lead Based Paint and/or Lead Based Paint Disclosure.
- 1. Buyer acknowledges receipt of these Disclosure Statements prior to execution of this Agreement of Sale.

**IN WITNESS WHEREOF,** intending to be legally bound, the parties have caused this Agreement to be duly executed, under seal, as of the day and year first above written.

WITNESS:	SELLER:
	BY:
WITNESS:	BUYER:
	BY:
WITNESS:	BUYER:
	BY: